



SUBJECT SITE

LOW DENSITY RESIDENTIAL

MEDIUM DENSITY RESIDENTIAL

PUBLIC RECREATION

PARKLAND / PUBLIC OPEN SPACE

MIXED USE BUILDING

INSTITUTIONAL

EXISTING BUS INTERCHANGE









INTERNAL VIEW - LOOKING SOUTH











DEVELOPMENT SCHEDULE

Site Area21438 m²Site Coverage (Building footprint only)66.0%Permeability9.0%

				RESIDENTIAL					SERVICES/CIRC	RETAIL	MEDICAL	CA	ARPARK	BALCONIES
					MIX			TOTAL	& Communal					
		Ave 64m2	Ave 76m2	Ave 79m2	Ave 92 m2	Ave 102m2	Ave 121 m2							
	Area	1 Bed	1 Bed + S	2 Bed + 1 Ba	2 Bed + 2 Ba	2B + 2Ba +S	3 Bed	APTS/FLOOR	Area	Area (GFA)	Area (GFA)	NO	Area	Area
Basement 01 (Residential)								0	2 403	0	500	134	6 413	
Lower Ground Floor (Residential & Retail)								0	849	544		331	11 841	
Ground Floor (Retail)								0	702	459		370	12 512	
Level 01	5 902	1	5	11	26	7	12	62	1 837					2 555
Level 02	6 514	1	3	9	35	7	13	68	935					1 385
Level 03	6 053	1	3	8	32	6	13	63	908					1 257
Level 04	4 455	1	2	5	25	3	10	46	815					1 031
Level 05	4 272	1	2	5	23	3	10	44	797					643
Totals	27 196	5	15	38	141	26	58	i	9 246	1 003	500	835	30 766	6 871
					TOTAL	APARTMENTS =	283					sqm/car =	36.8	
		2%	5%	13%	50%	9%	20%							

NO:12026 DATE: 11/01/2018 REVISION: 3

CAR PARK ANALYSIS									VISITORS
RATE	1.000	1.000	1.000	1.000	1.000	2.000	0.040	10 suites	0.200
REQUIRED CARS	5	15	38	141	26	116	40	32	56.0

PROPOSED TOTAL PROVISION FOR DEVELOPMENT	442
PROPOSED PROVISION FOR EXISTING RETAIL (WITHIN SUBJECT SITE)	393

PROPOSED TOTAL CAR PARKING PROVISION

Refer to Transport Impact Assessment Report

Public	Residential	Total
	4	4
4	4	8
8		8
12	8	20
	Public 4 8 12	Public Residential

835

Residential Visitor Parking (included in above totals)	
Basement	16
Lower Ground	12
Total	28

Bicycle Parking	Public	Residential	Total
Basement	8		8
Lower Ground	8	30	38
Ground Floor	12		12
Total	28	30	58

Storage Cages	
Basement	234
Lower Ground	41
Level 04	4
Level 05	4
Total	283



		Ave 64m2	Ave 76m2	Ave 79m2	Ave 92 m2	Ave 102m2	Ave 121 m2	
	Area	1 Bed	1Bed + S	2 Bed + 1 Ba	2 Bed + 2 Ba	2 B + 2 Ba + S	3 Bed	APTS PER BUILDING
Α	10 117	5	11	6	58	5	21	106
В	3 996	0	0	10	23	0	9	42
С	9 079	0	4	16	47	7	20	94
D	4 003	0	0	6	13	14	8	41
Totals	27 195	5	15	38	141	26	58	
					TOTAL	APARTMENTS =	283	
		2%	5%	13%	50%	9%	20%	





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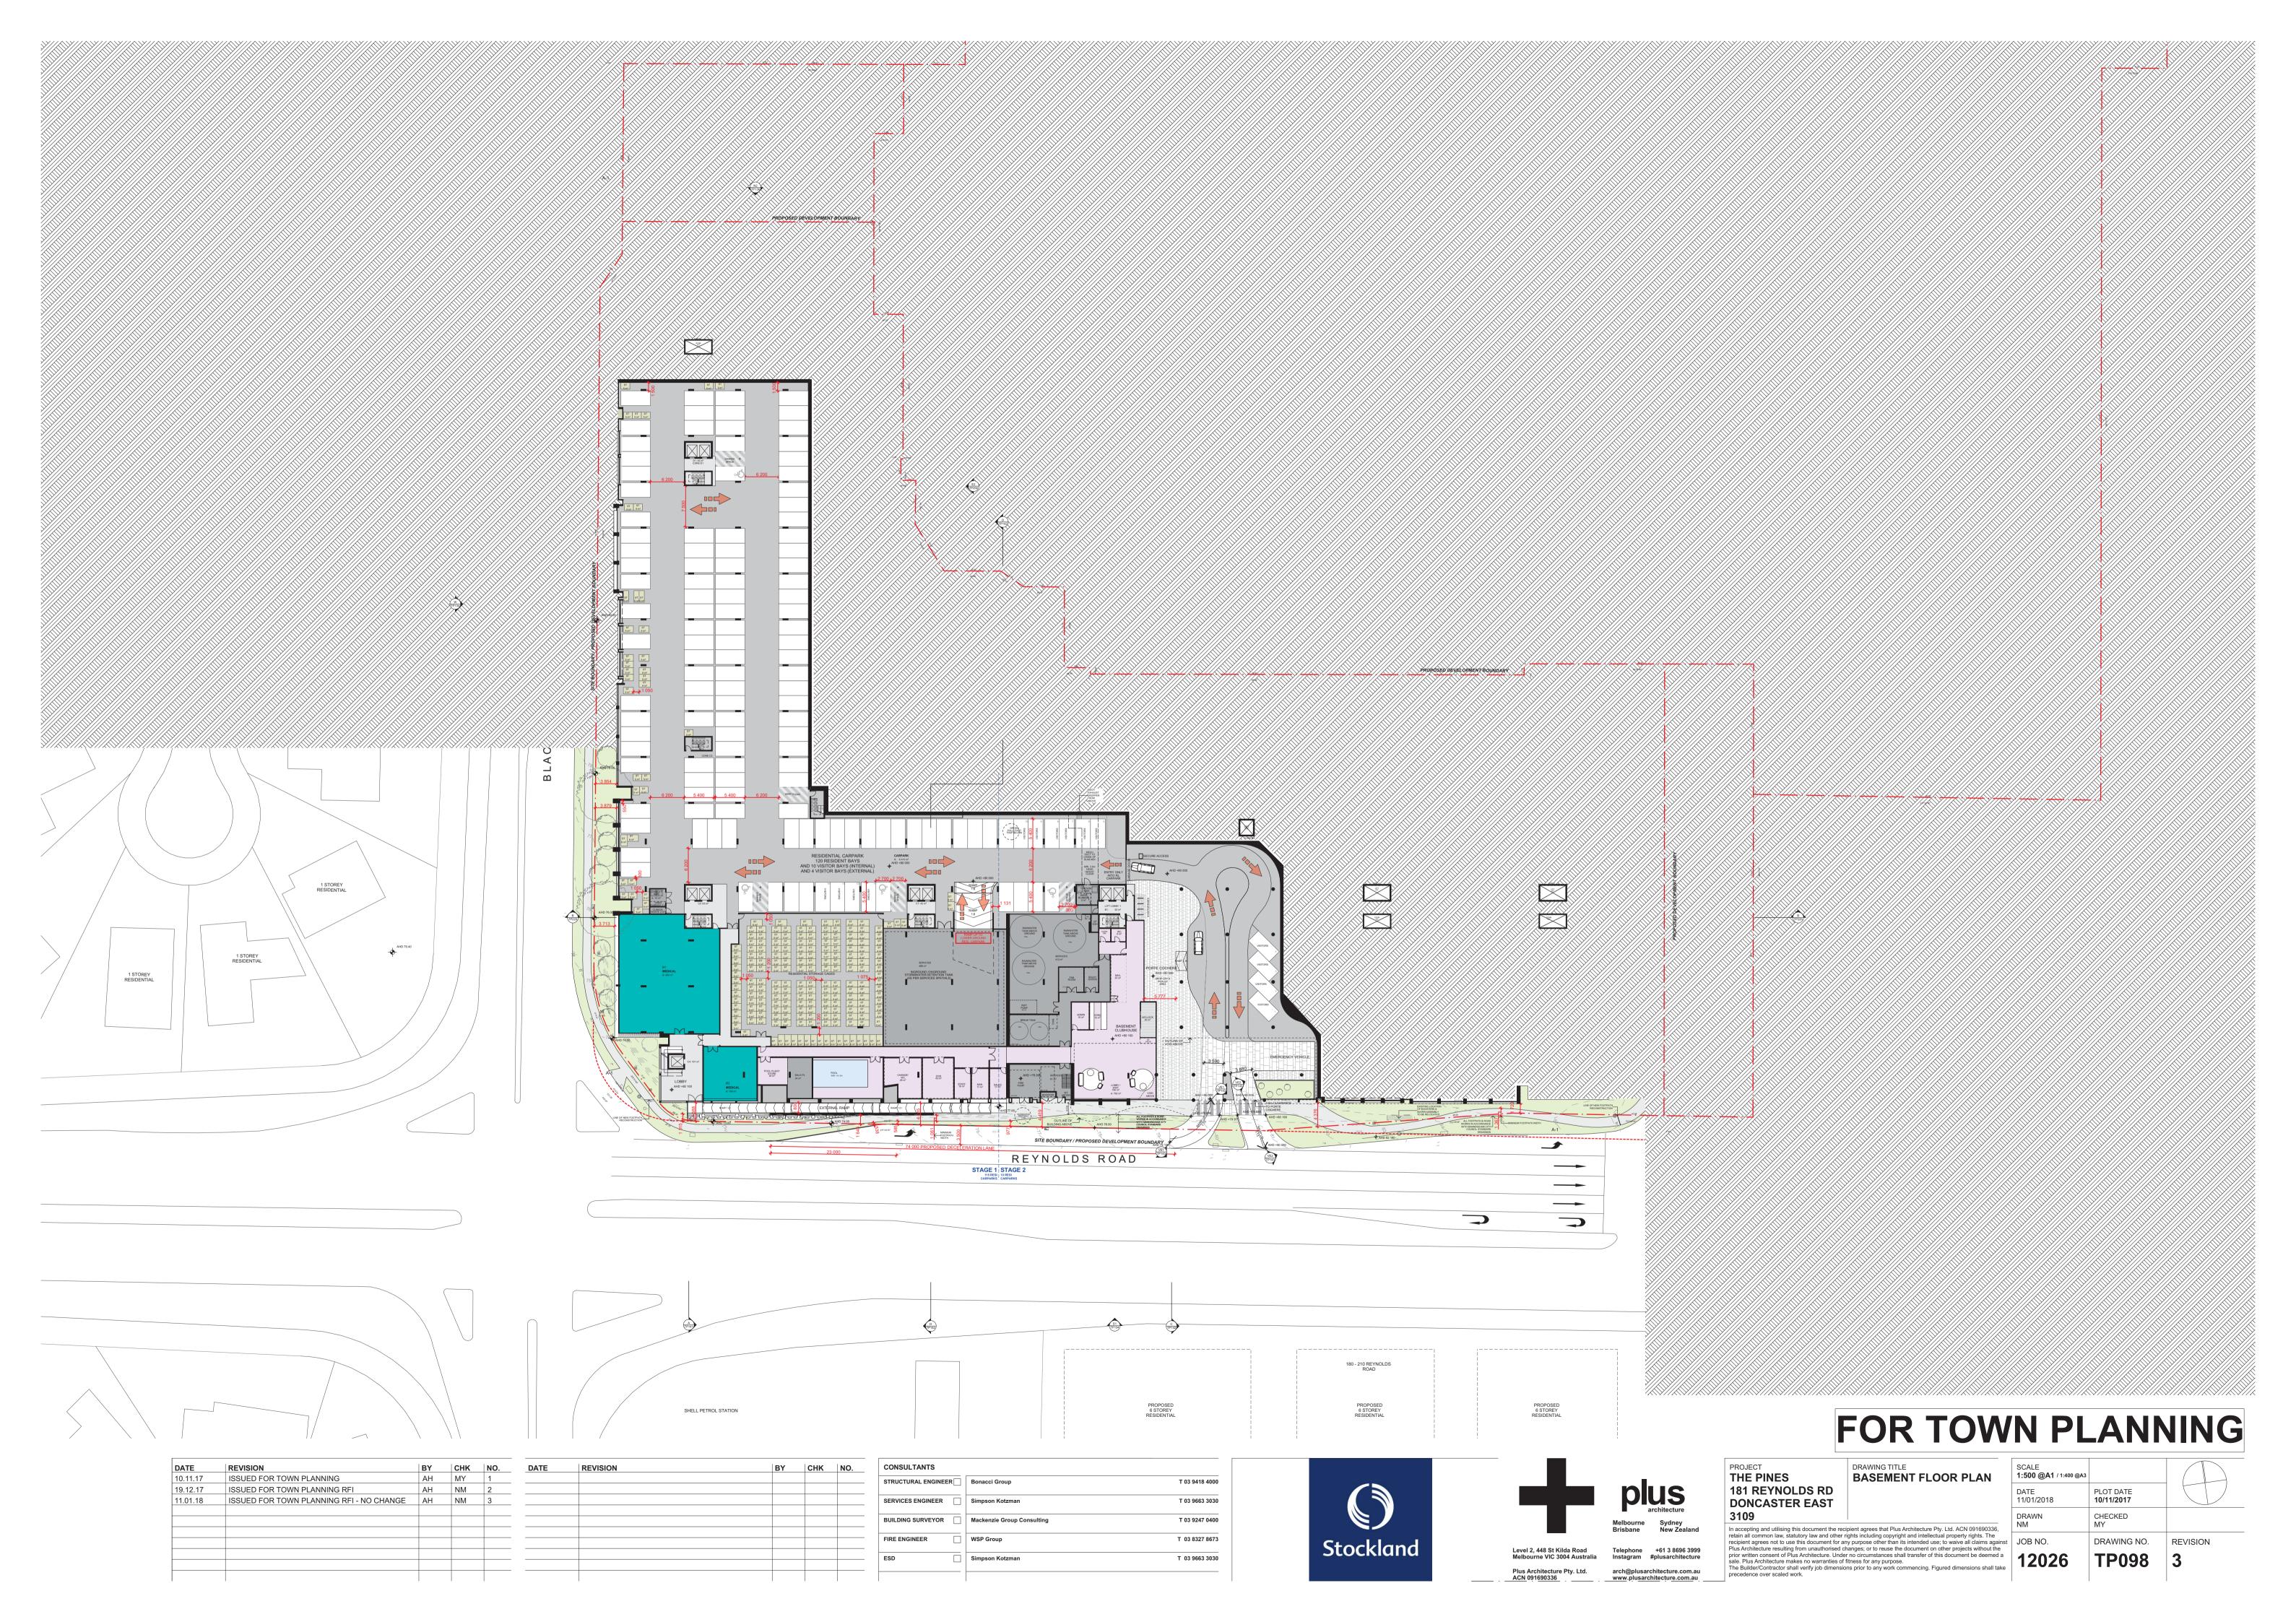
			RESIDENTIAL		CARPARK				
					MIX			TOTAL	
STAGE 1 ONLY	Area	1 Bed	1 Bed + S	2 Bed + 1 Ba	2 Bed + 2 Ba	2B + 2Ba +S	3 Bed	APTS/FLOOR	NO
Basement 01 (Residential)								0	115
Lower Ground Floor (Residential & Retail)								0	143
Ground Floor (Retail)								0	188
Level 01	3 418	0	2	7	15	6	6	36	
Level 02	3 433	0	1	6	17	6	6	36	
Level 03	2 973	0	1	5	14	5	6	31	
Level 04	1 629	0	0	2	7	2	5	16	
Level 05	1 629	0	0	2	7	2	5	16	
Totals	13 082	0	4	22	60	21	28		446
					TOTAL	APARTMENTS =	135		


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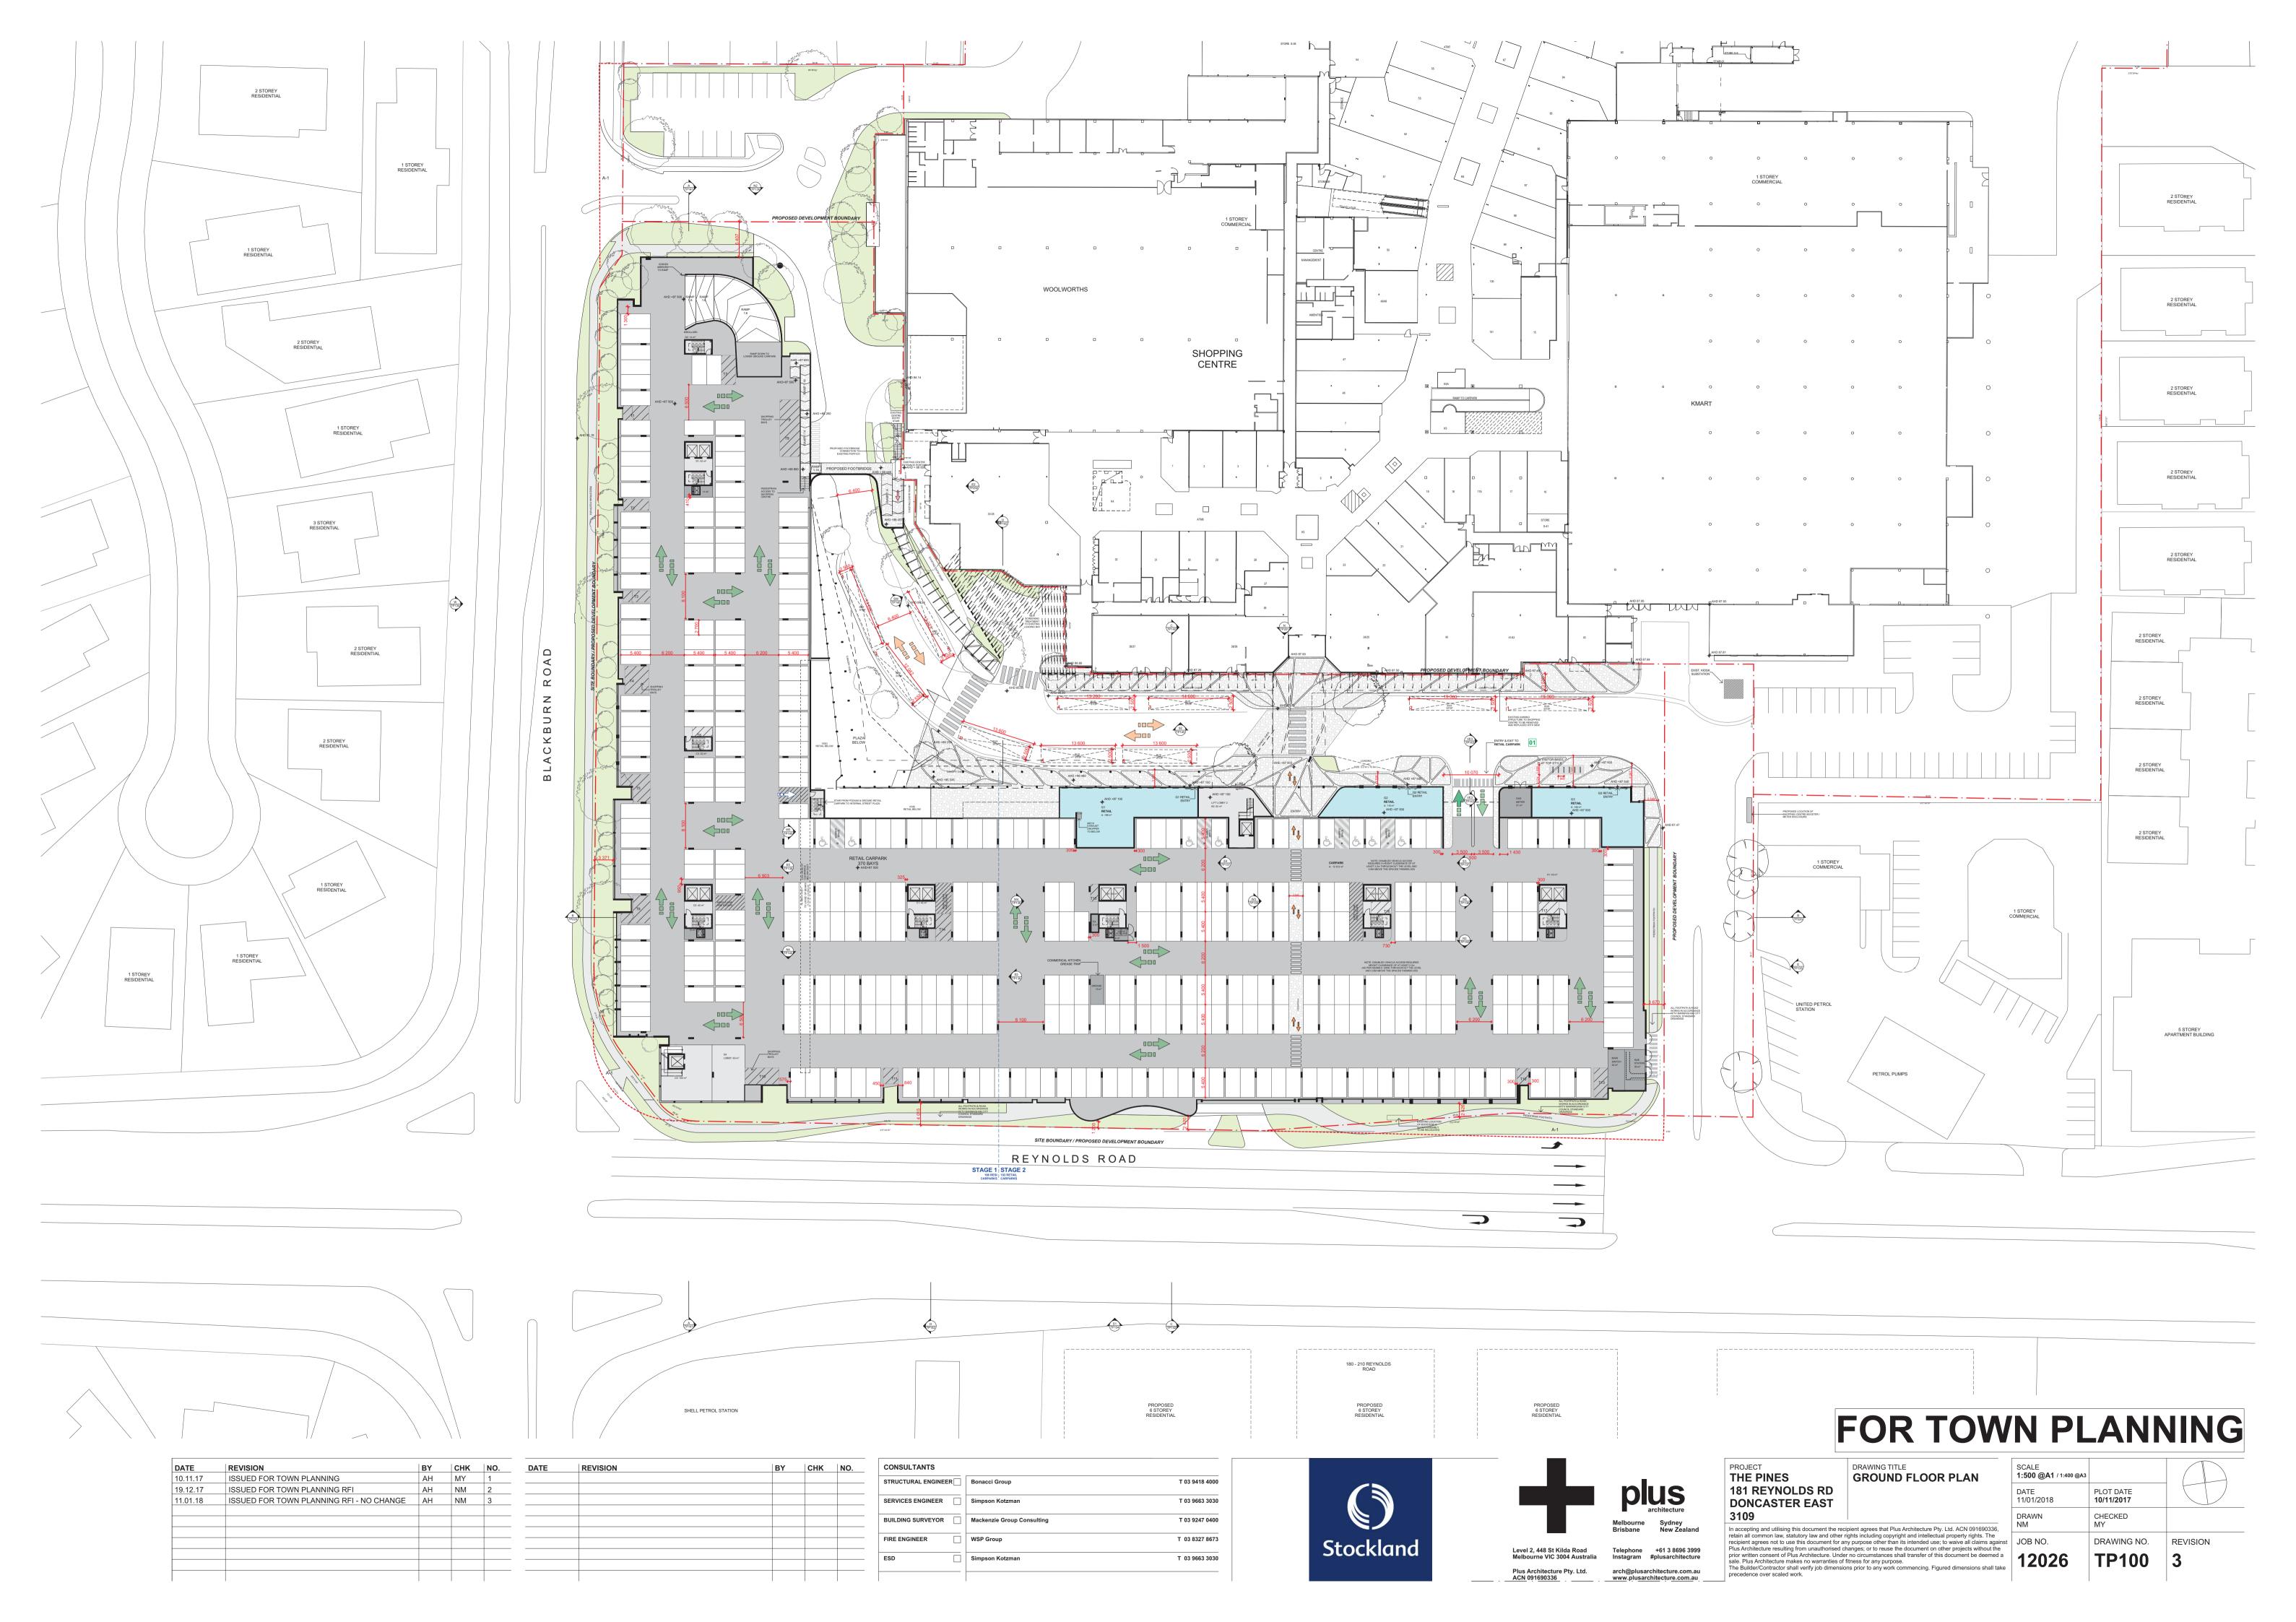






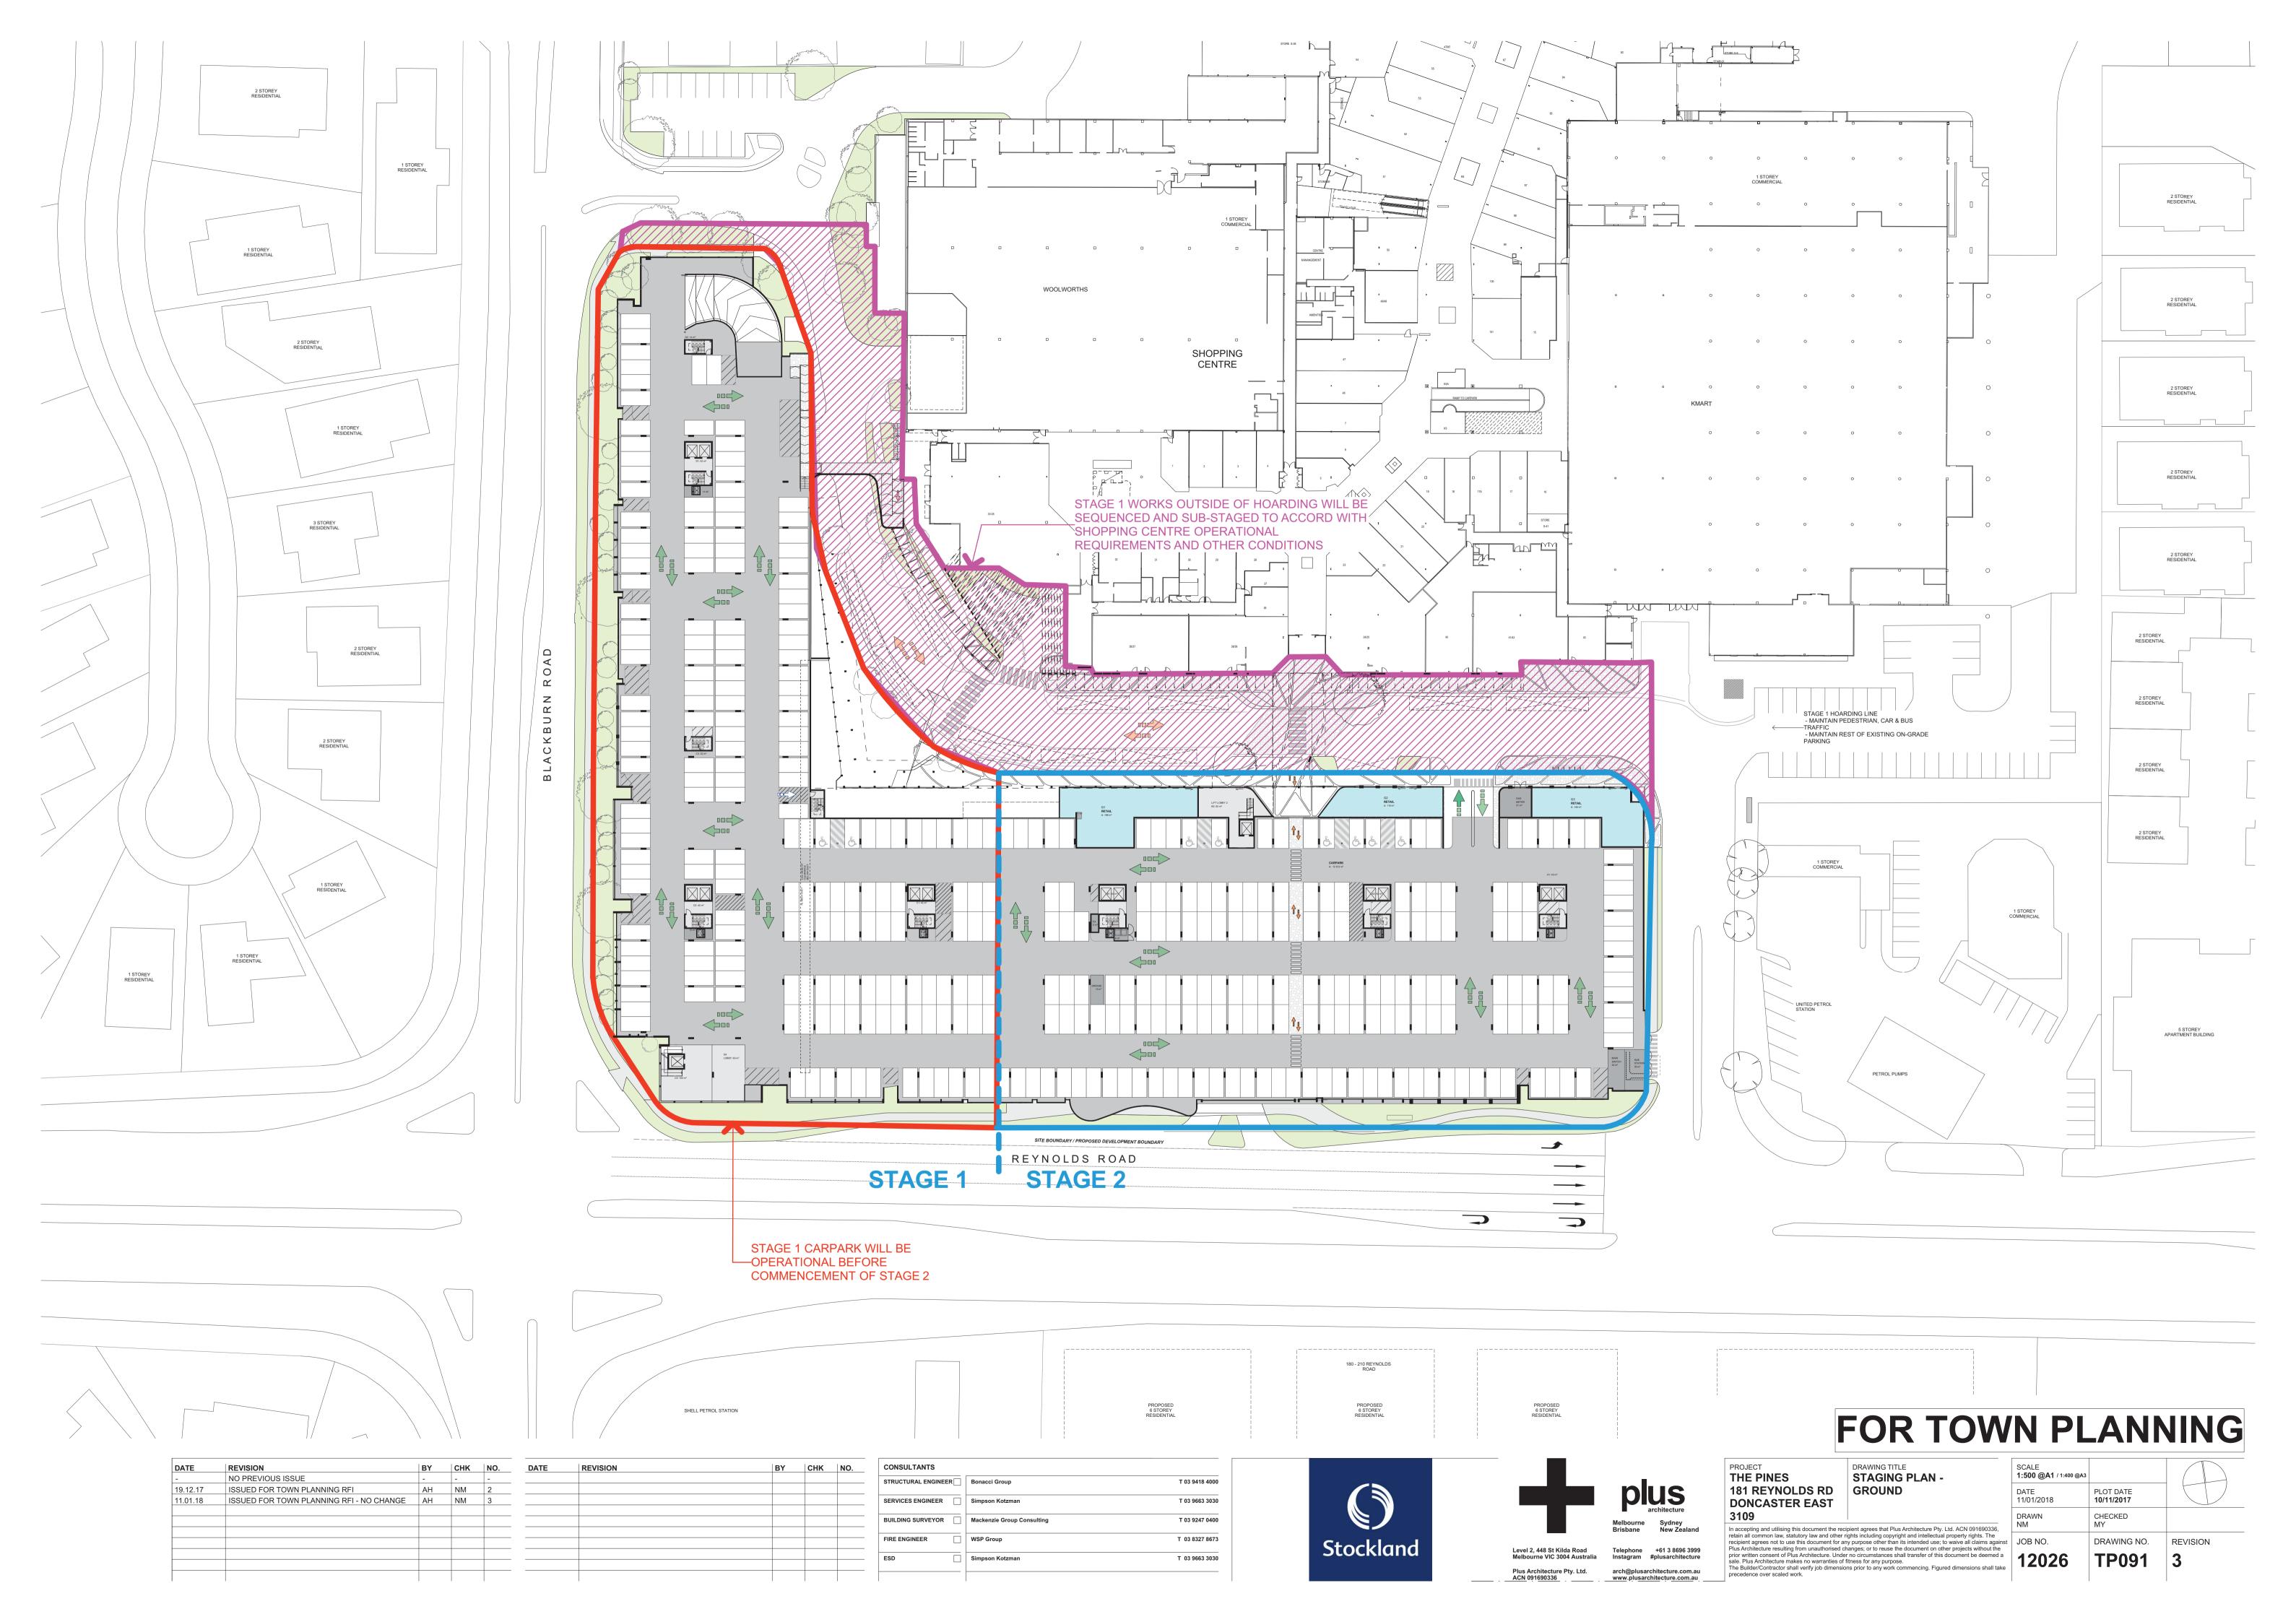

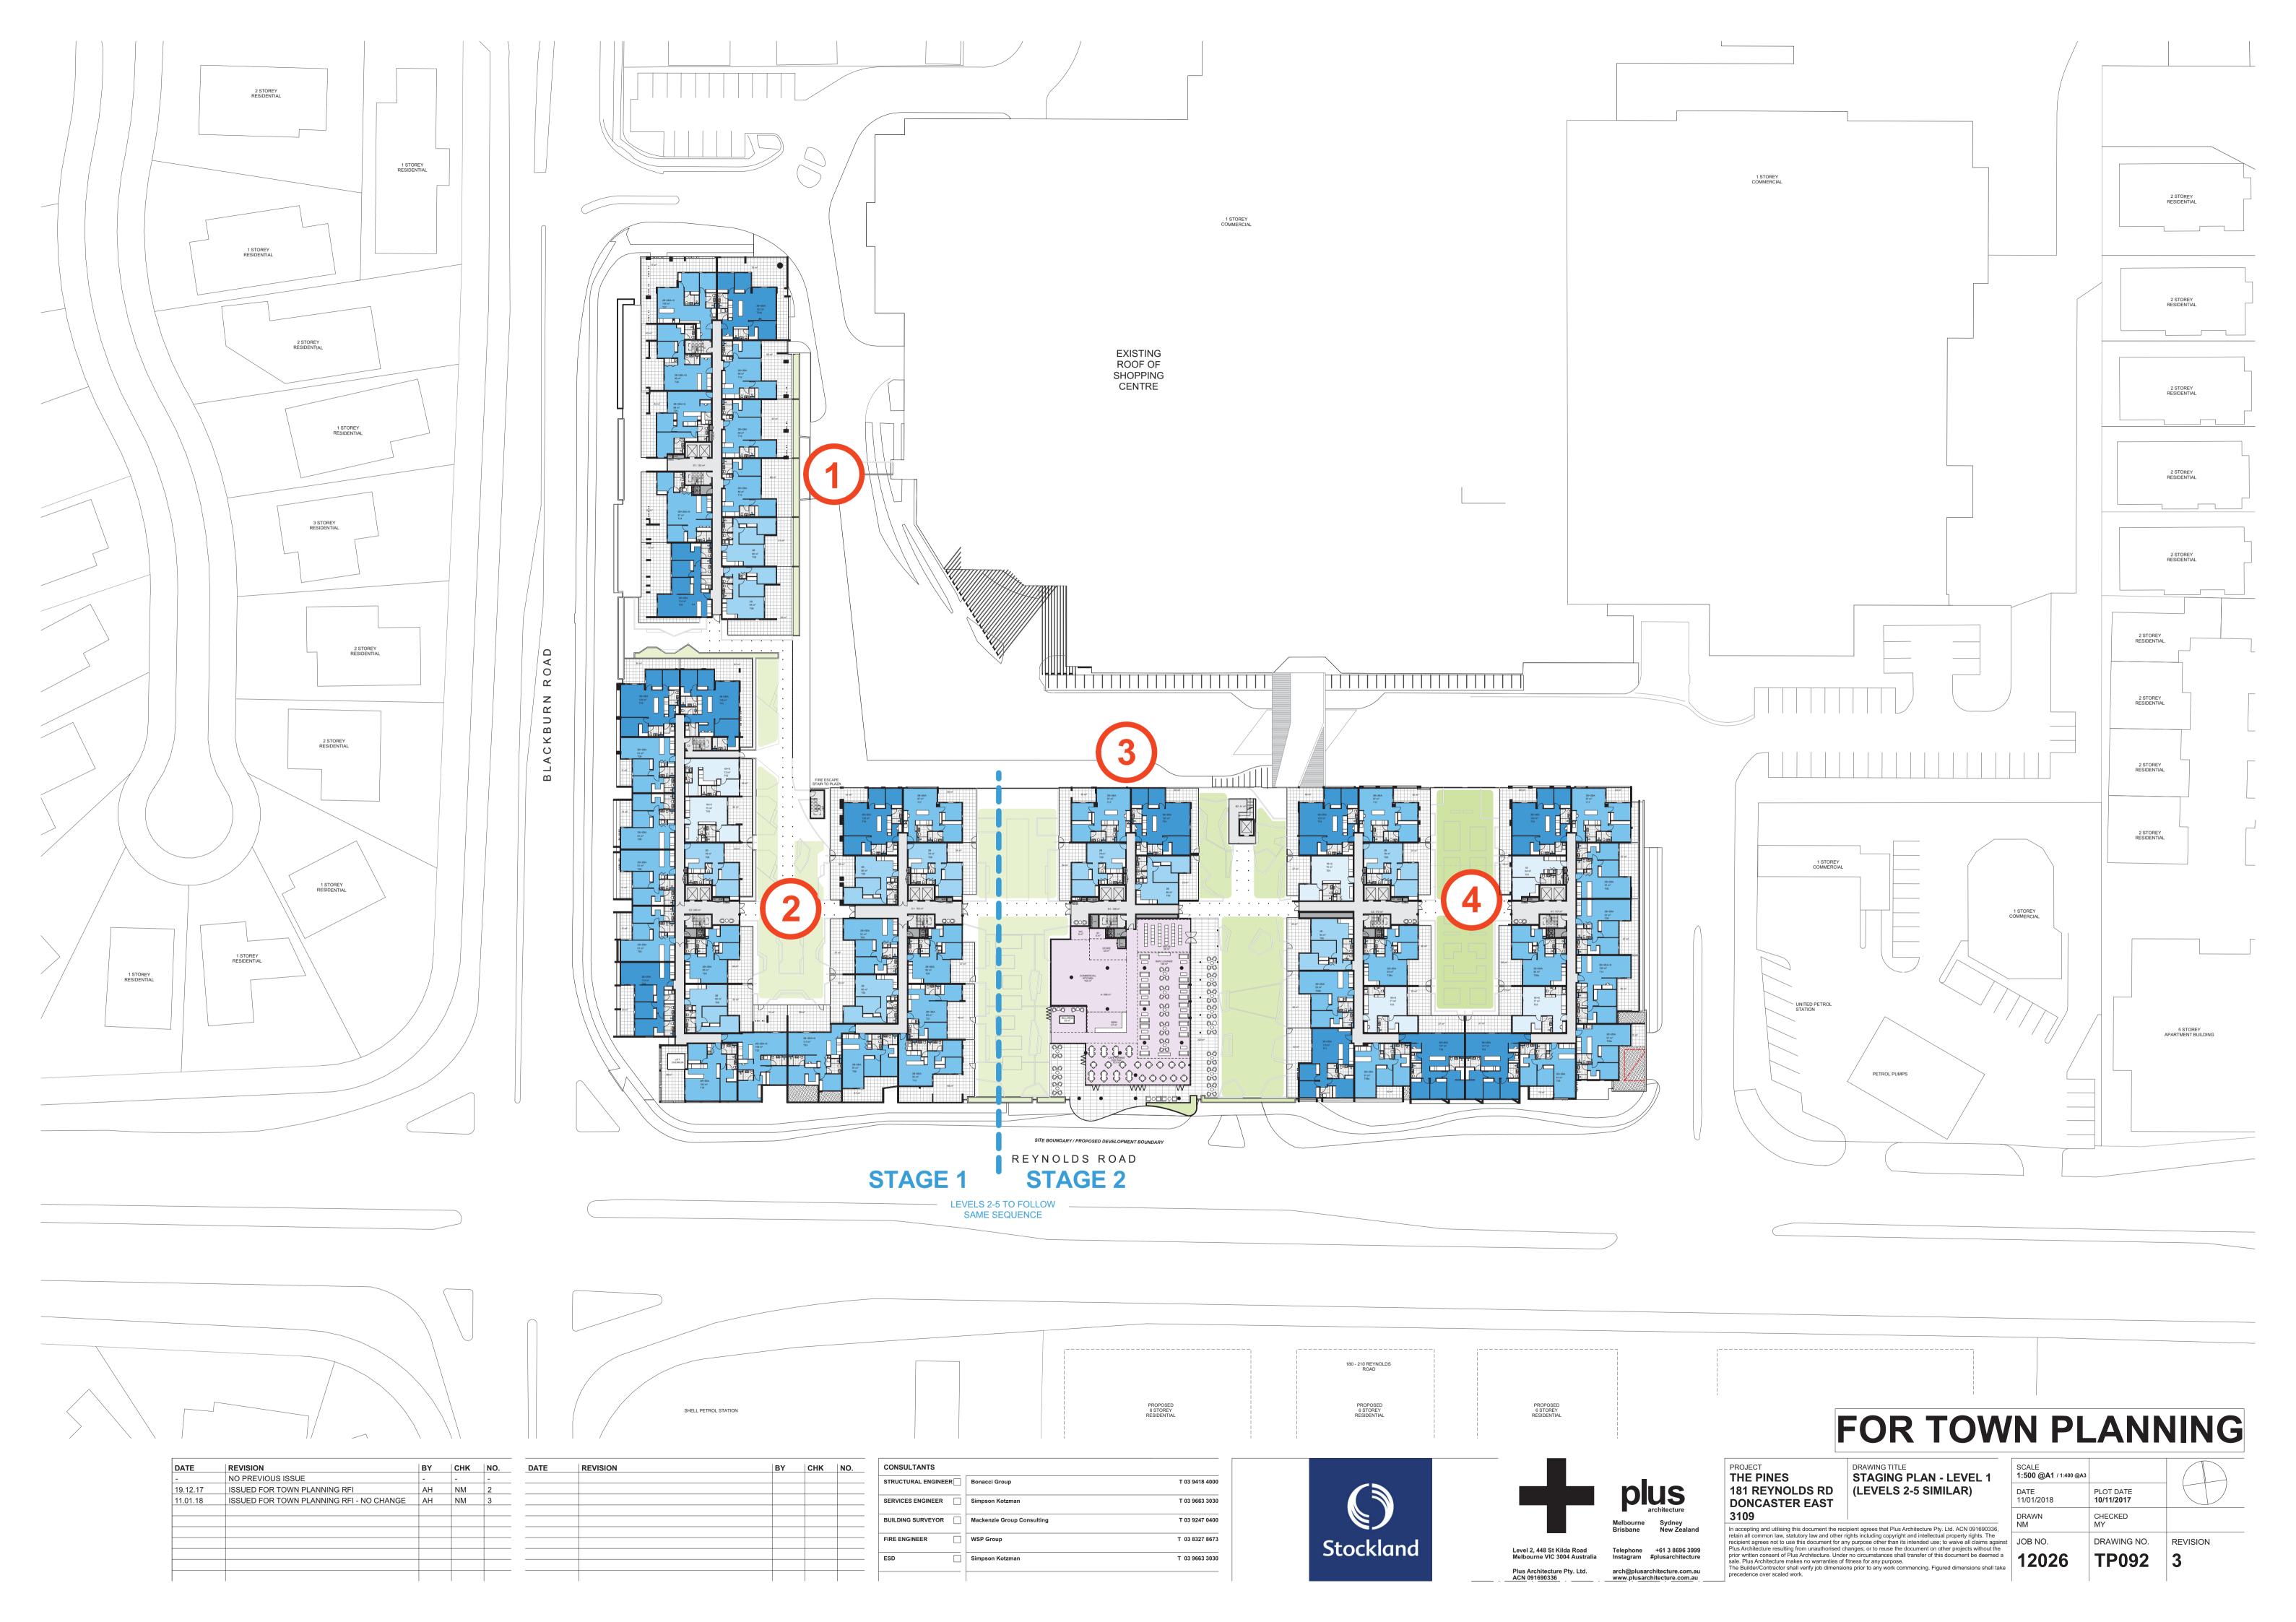

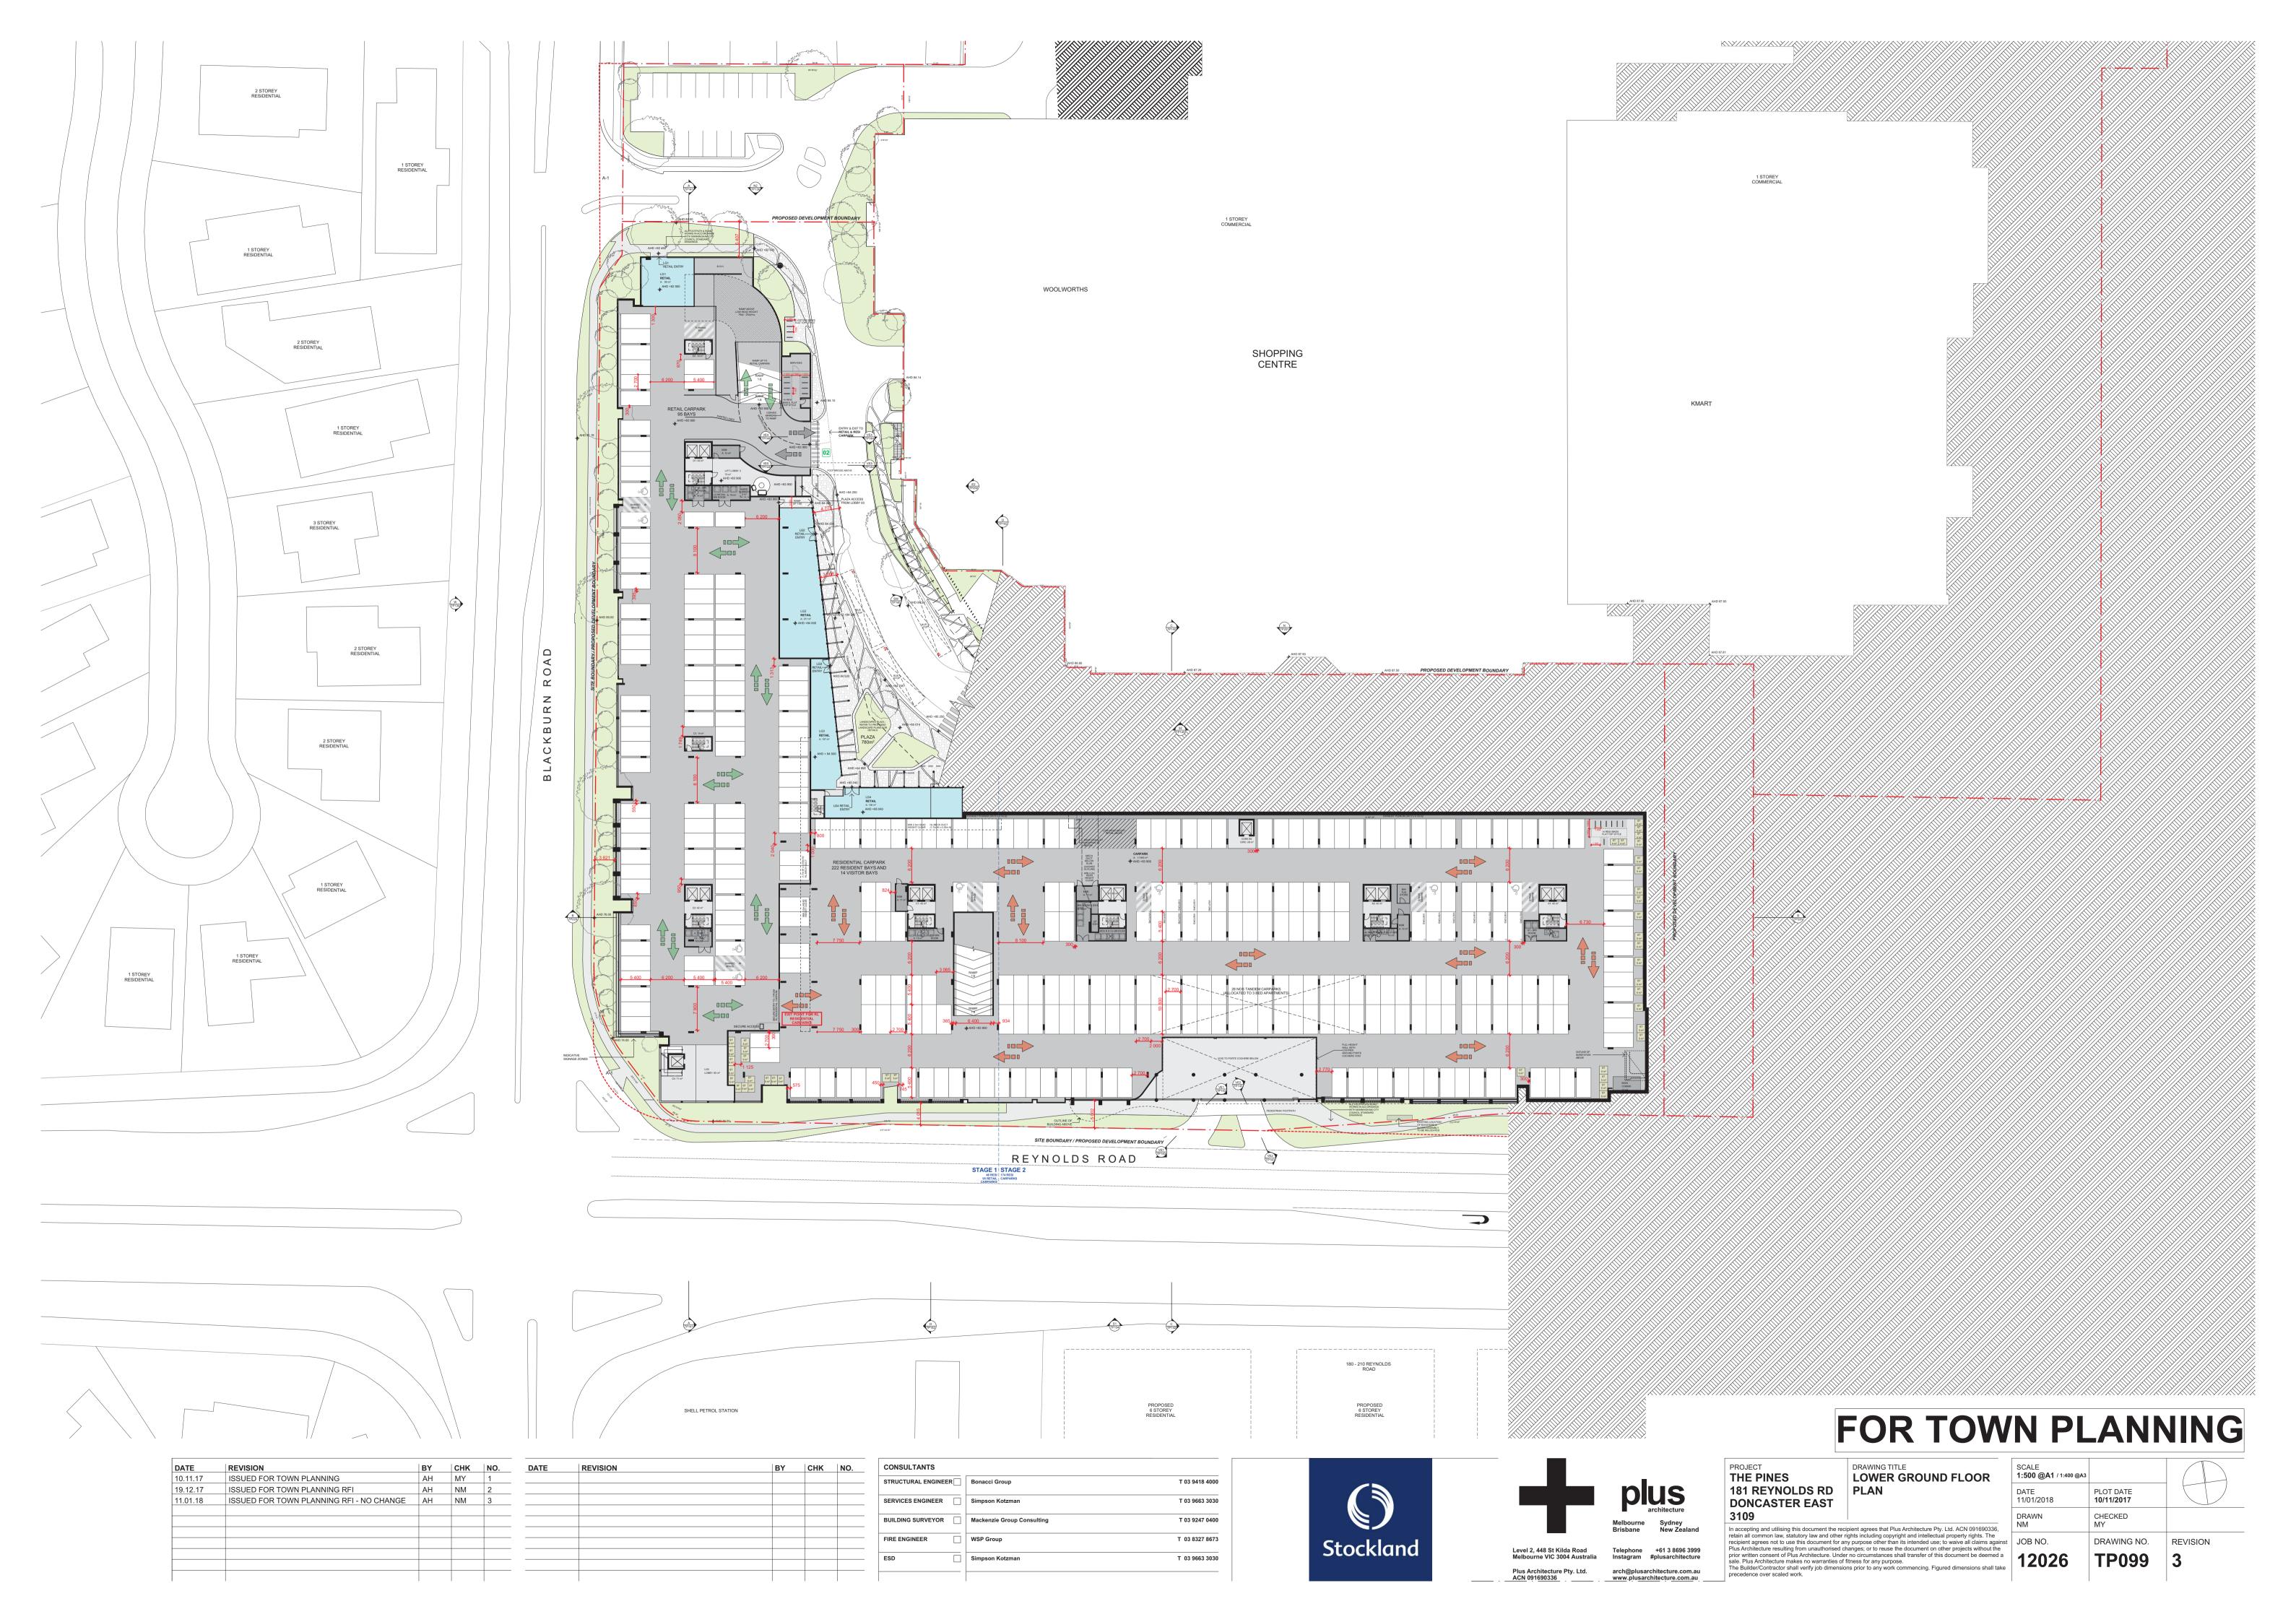













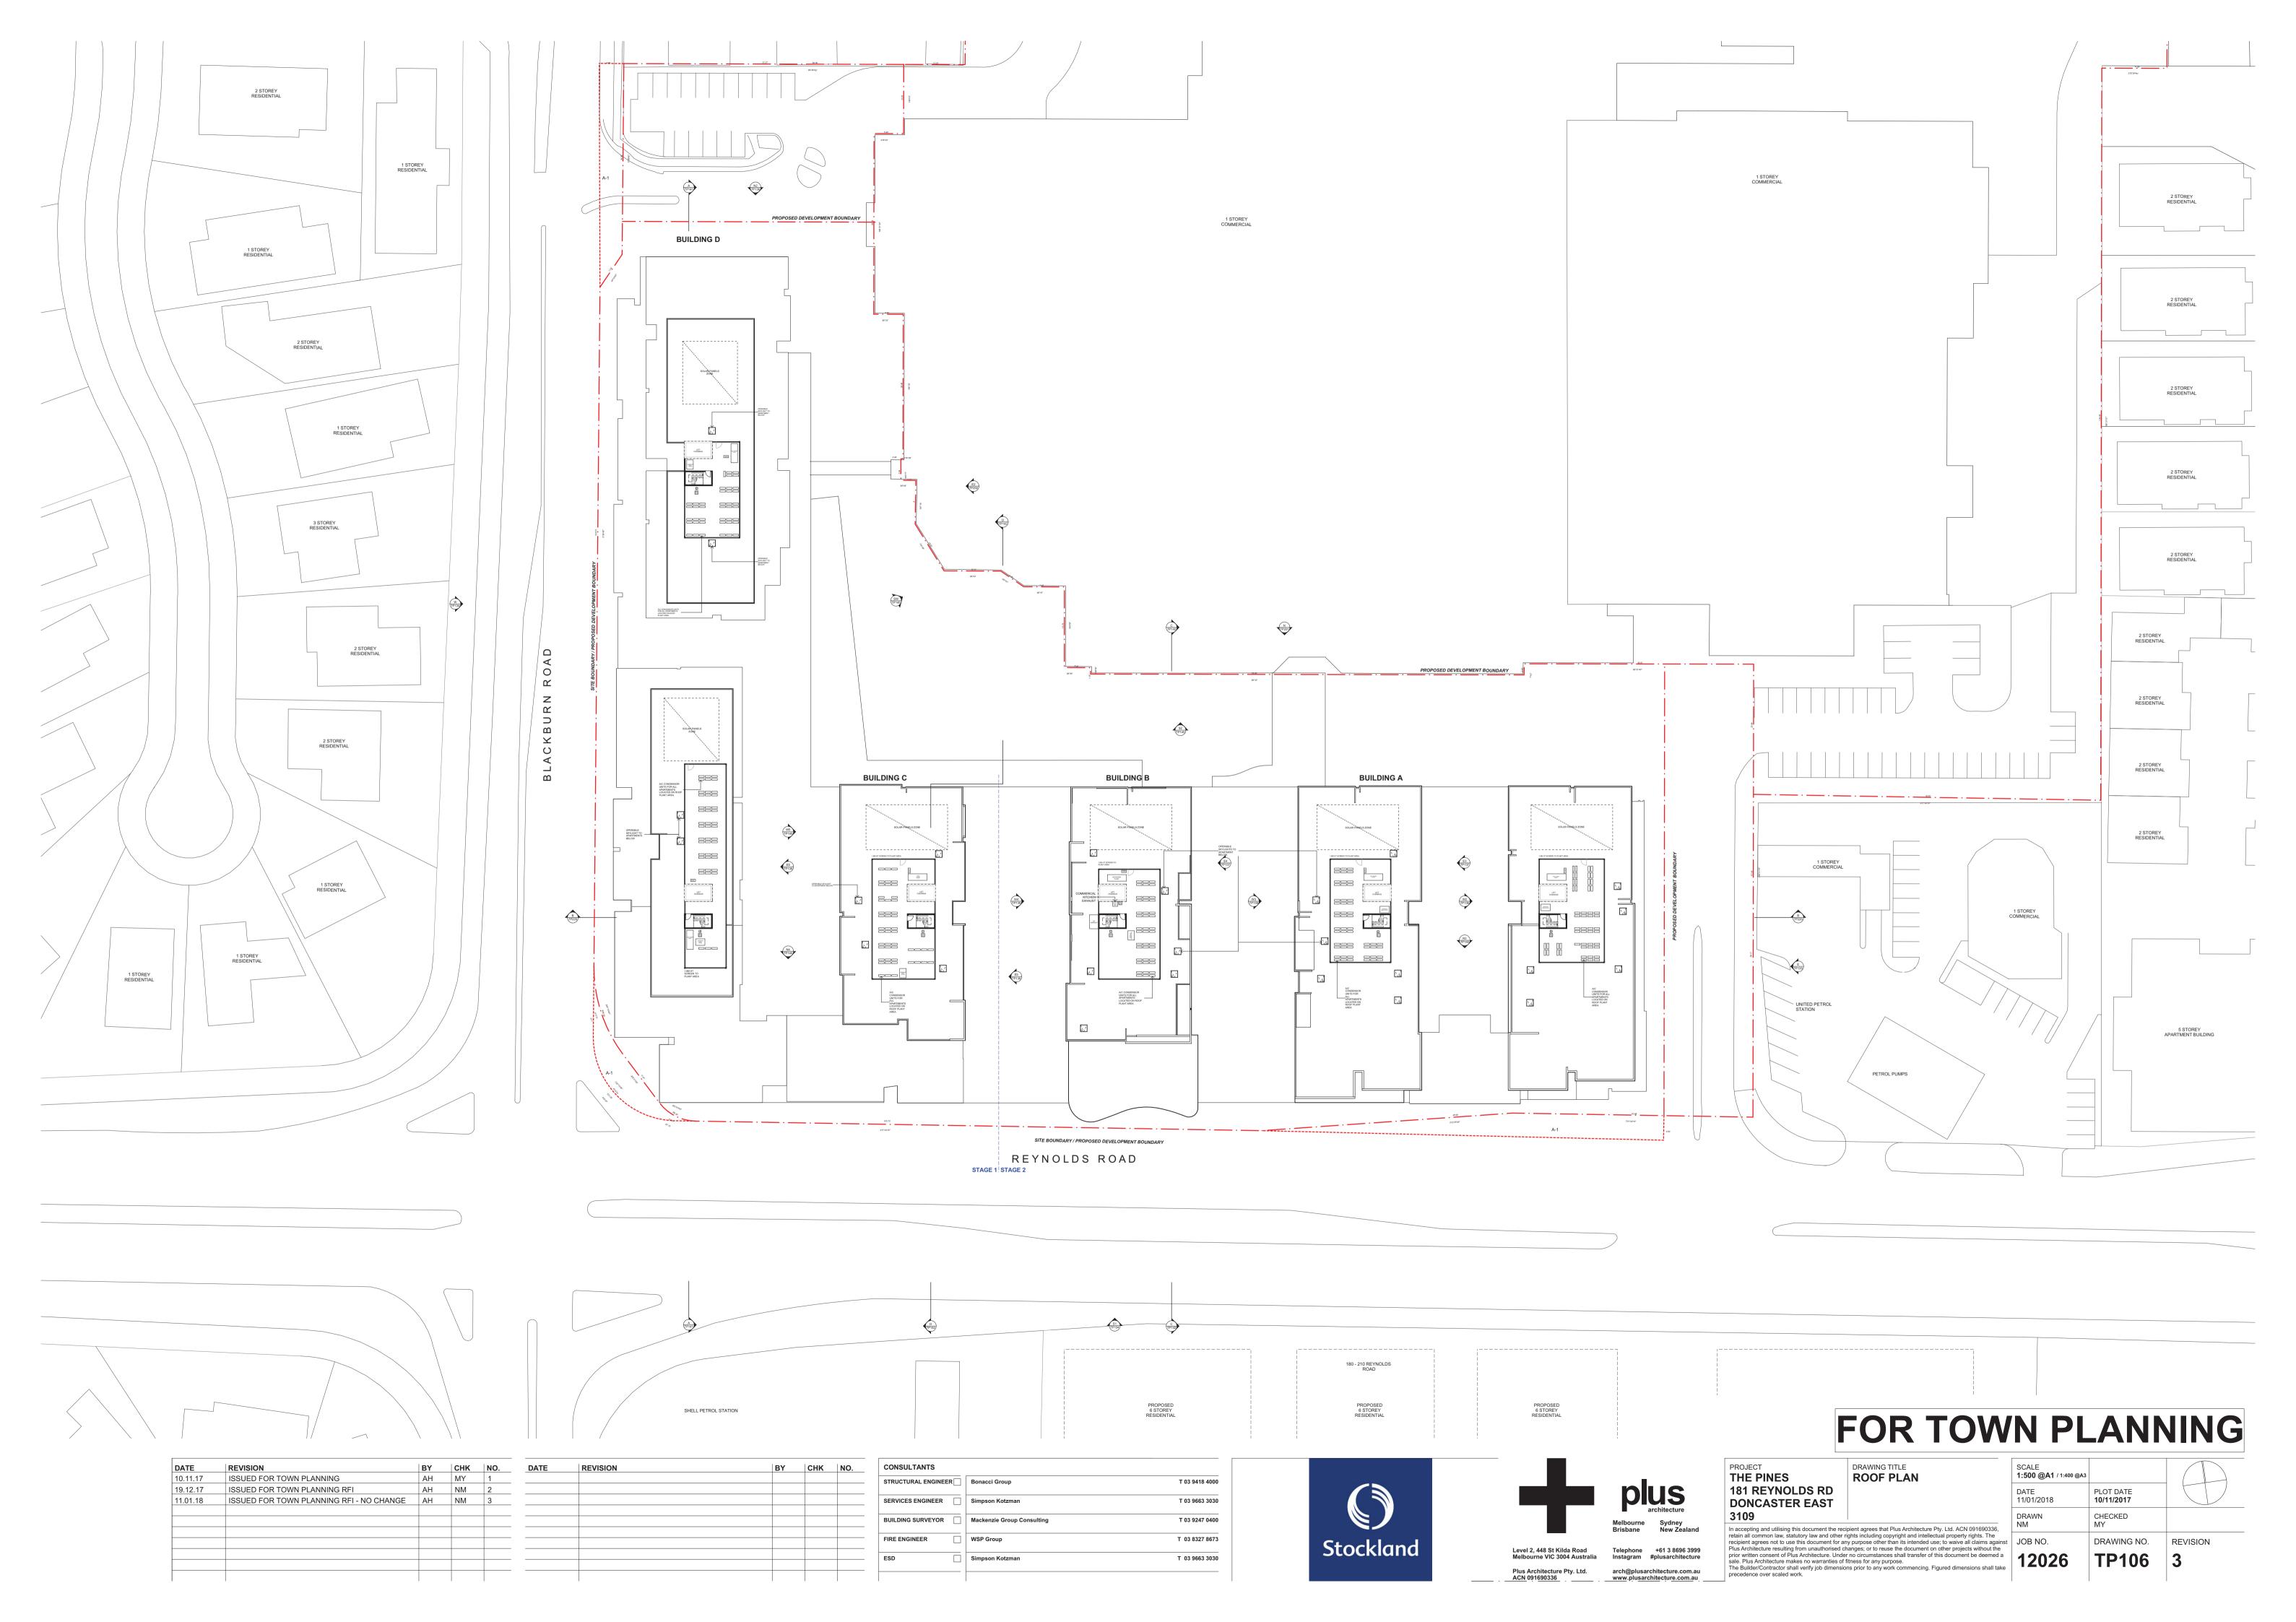

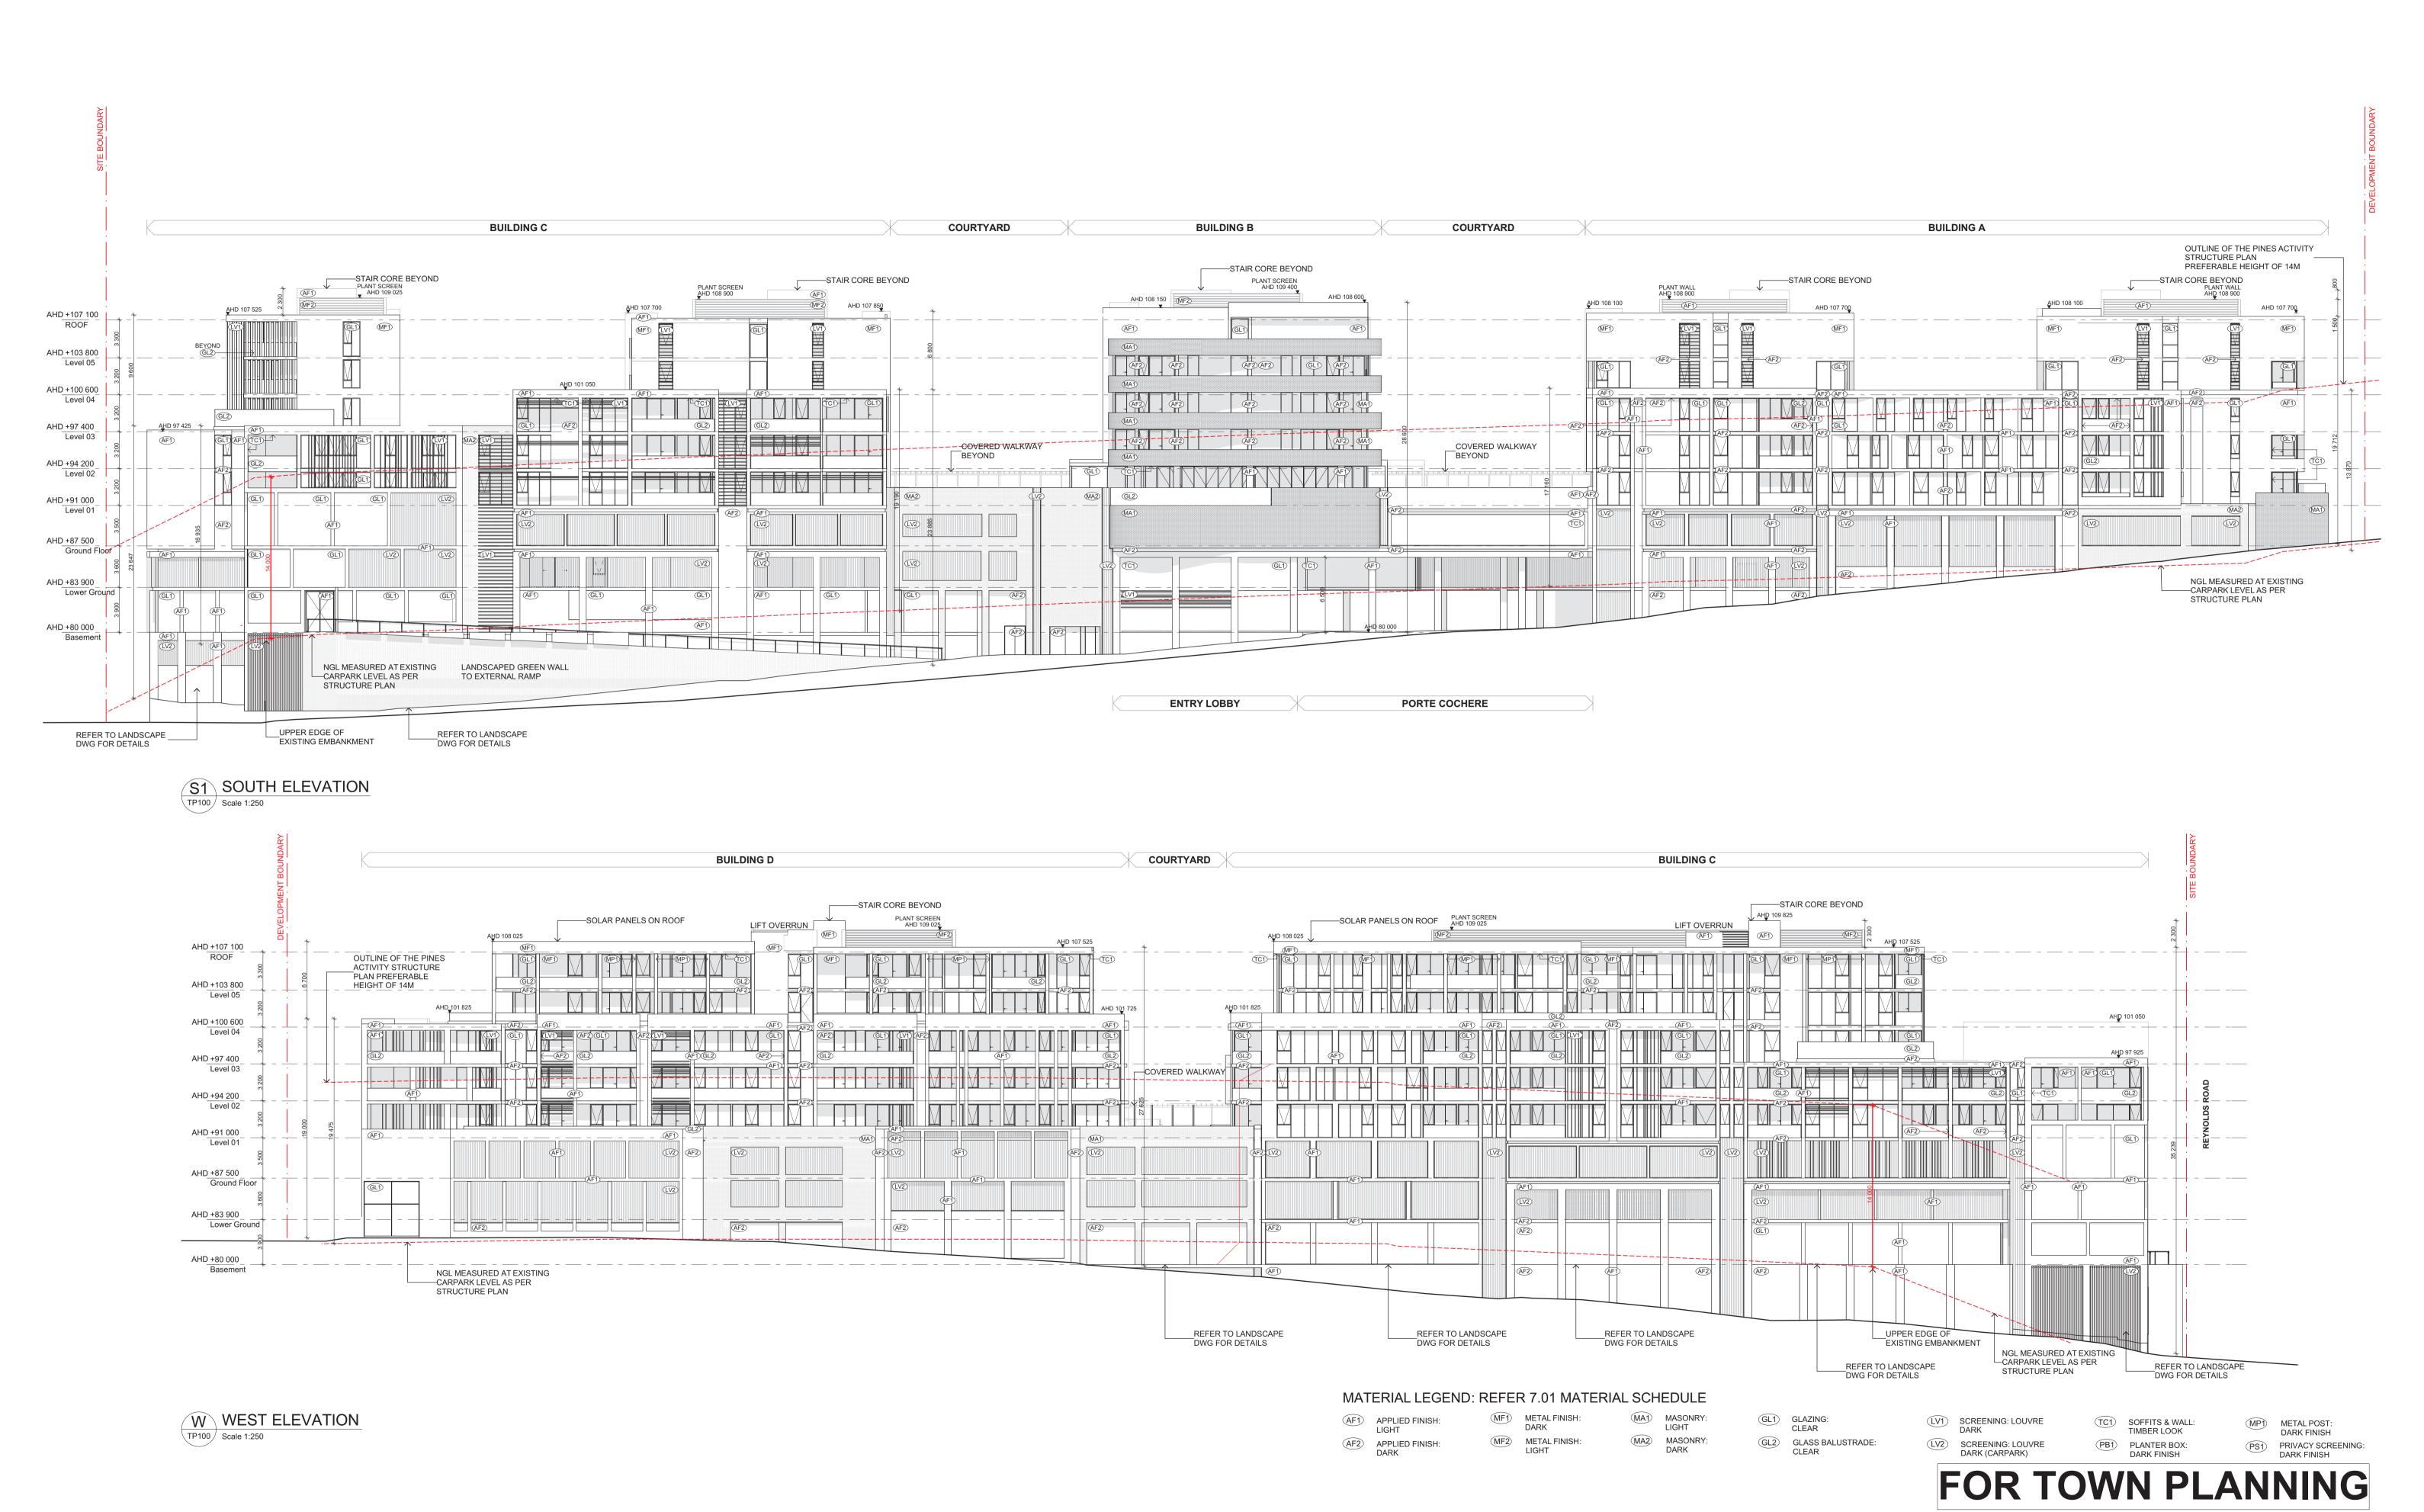








	pl	US	
	Melbourne Brisbane	Sydney New Zealand	
ia	Telephone Instagram	+61 3 8696 3999	

arch@plusarchitecture.com.au www.plusarchitecture.com.au

PROJECT THE PINES	DRAWING TITLE WEST & SOUTH	SCALE 1:250 @A1 / 1:500 @A3	PLOT DATE 10/11/2017	
181 REYNOLDS RD DONCASTER EAST	ELEVATION	DATE 10/11/2017		
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REVISION



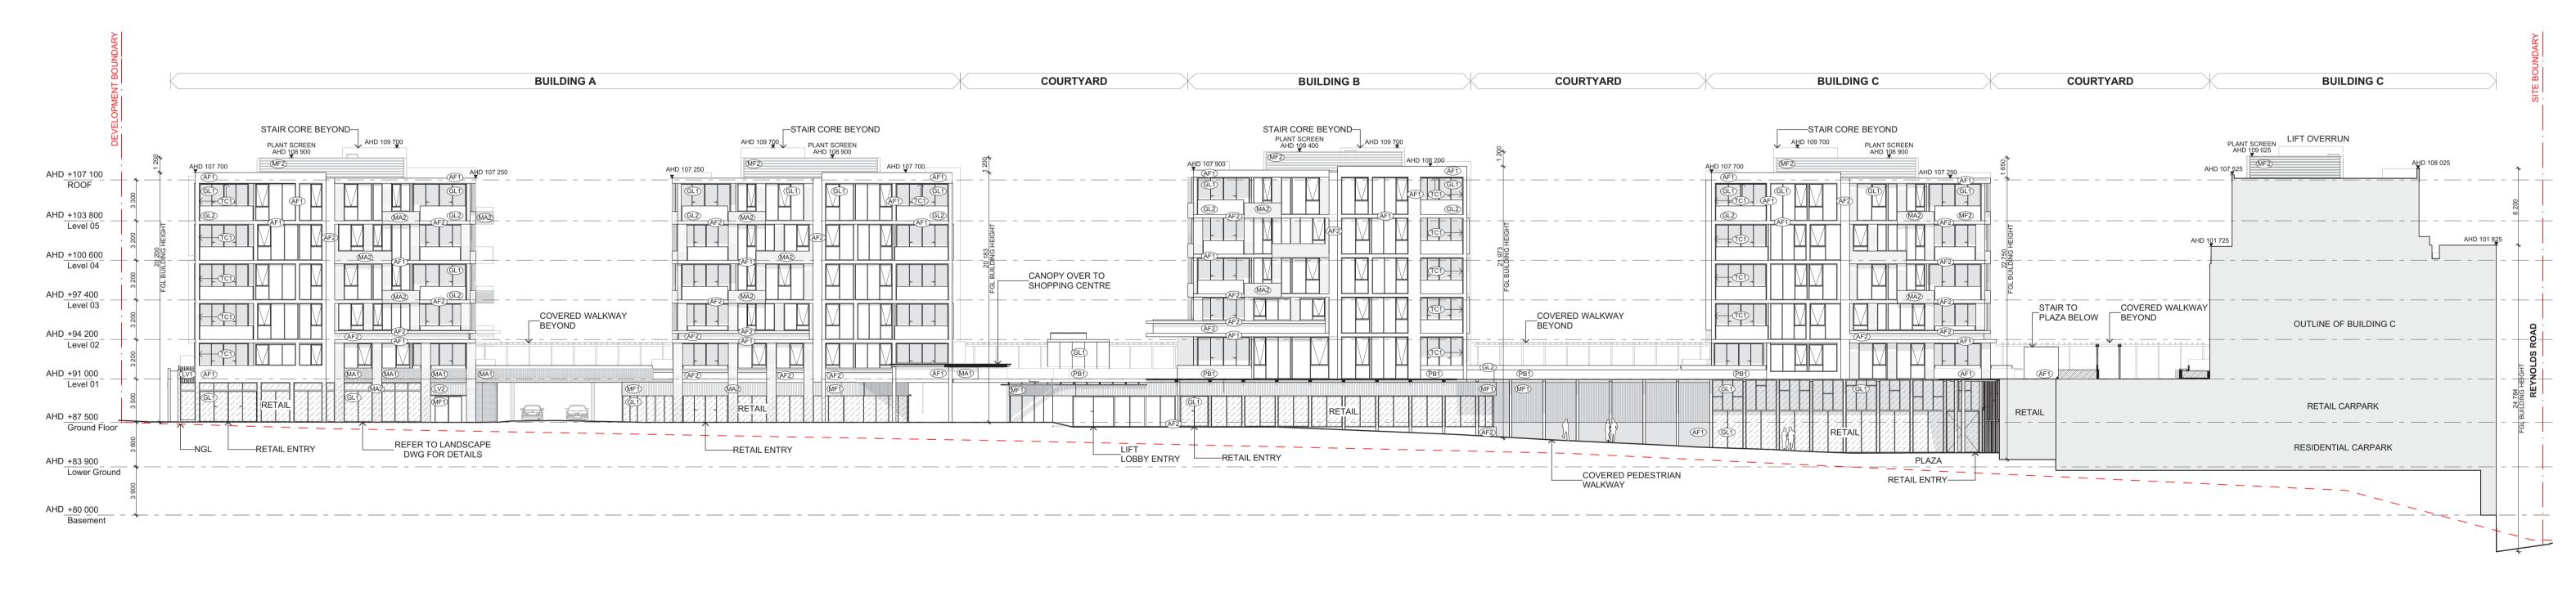

T 03 8327 8673

T 03 9663 3030

WSP Group

Simpson Kotzman

NORTH ELEVATION
TP100 Scale 1:250

MATERIAL LEGEND: REFER 7.01 MATERIAL SCHEDULE

AF1 APPLIED FINISH: MF1 METAL FINISH: MA1 MASONRY: LIGHT

AF2 APPLIED FINISH: MF2 METAL FINISH: MA2 MASONRY: DARK

MA1 MASONRY: DARK

GL1 GLAZING: CLEAR
GL2 GLASS BALUSTRADE: CLEAR

LV1 SCREENING: LOUVRE DARK

LV2 SCREENING: LOUVRE DARK (CARPARK)

TC1 SOFFITS & WALL:
TIMBER LOOK

PB1 PLANTER BOX:
DARK FINISH

FOR TOWN PLANNING

MP1 METAL POST:
DARK FINISH
PS1 PRIVACY SCREENING:
DARK FINISH


DATE	REVISION	BY	CHK	NO.	DATE	REVISION	BY	CHK	NO.	CONSULTANTS		
10.11.17	ISSUED FOR TOWN PLANNING	AH	MY	1						STRUCTURAL ENGINEER	Bonacci Group	T 03 9418 4000
19.12.17	ISSUED FOR TOWN PLANNING RFI	AH	NM	2								
										SERVICES ENGINEER	Simpson Kotzman	T 03 9663 3030
										BUILDING SURVEYOR	Mackenzie Group Consulting	T 03 9247 0400
								_				






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s. The ms against hout the	JOB NO.	DRAWING NO.	REVISION
leemed a	12026	TP135	3

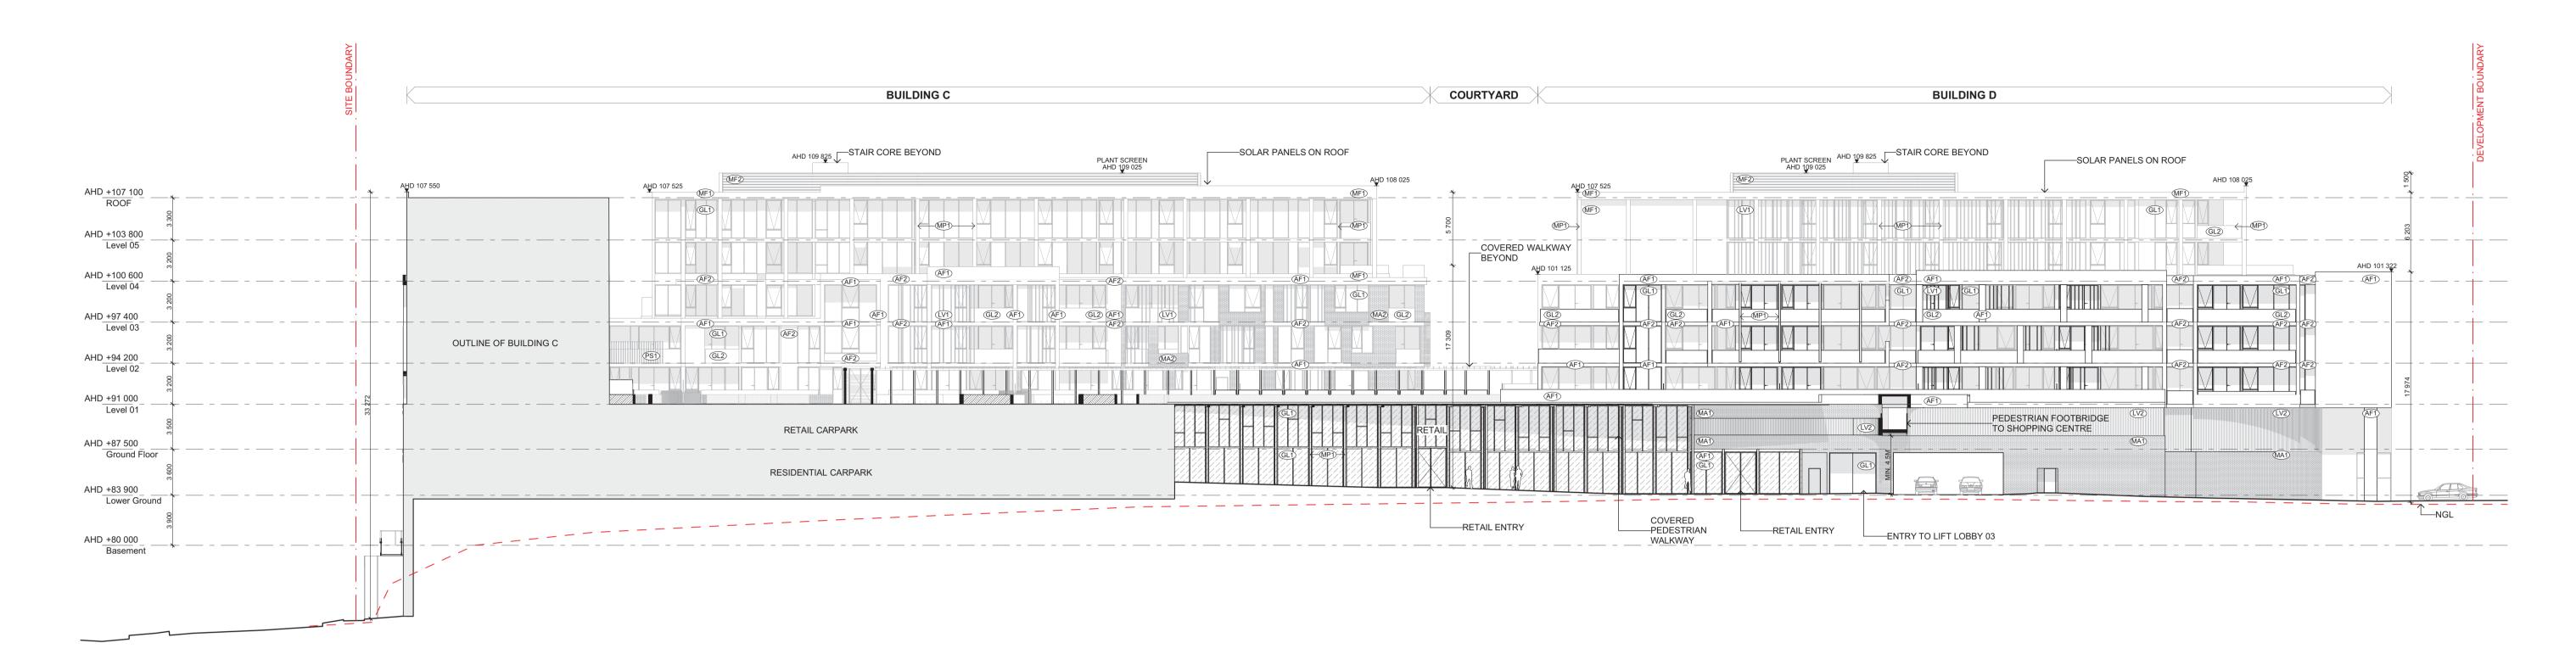

E2 EAST ELEVATION
TP100 Scale 1:250

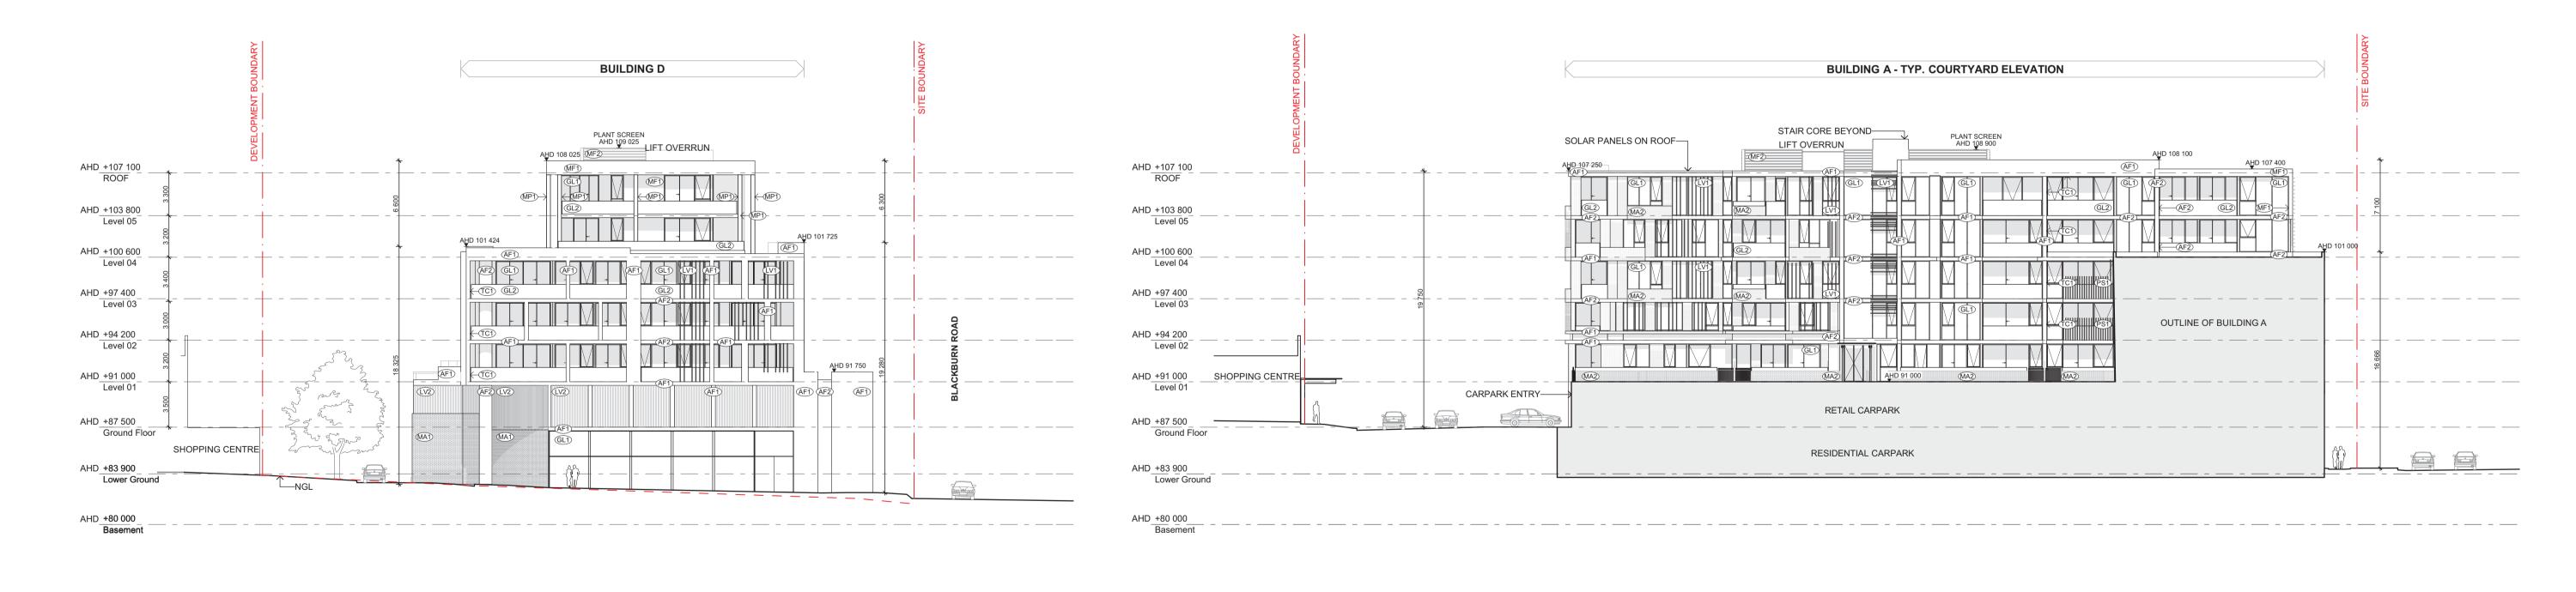

N2 NORTH ELEVATION
TP100 Scale 1:250

W2 WEST ELEVATION
TP100 Scale 1:250

MATERIAL LEGEND: REFER 7.01 MATERIAL SCHEDULE

AF2 APPLIED FINISH: DARK

AF2 APPLIED FINISH: DARK

MF2 METAL FINISH: LIGHT

LIGHT

MASONRY:

MASONRY:

DARK

GL1 GLAZING: CLEAR
GL2 GLASS BALUSTRADE: CLEAR

LV1 SCREENING: LOUVRE DARK

LV2 SCREENING: LOUVRE DARK (CARPARK)

ING: LOUVRE

TC1

SOFFITS & WALL:
TIMBER LOOK

IING: LOUVRE
PB1

PLANTER BOX:
DARK FINISH

MP1 METAL POST:
DARK FINISH
PS1 PRIVACY SCREENING:
DARK FINISH

FOR TOWN PLANNING ION BY CHK NO. DATE REVISION BY CHK NO. CONSULTANTS PROJECT DRAWING TITLE SCALE


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10.11.17	ISSUED FOR TOWN PLANNING	AH	MY	1						STRUCTURAL ENGINEER	Bonacci Group	T 03 9418 4000
19.12.17	ISSUED FOR TOWN PLANNING RFI	AH	NM	2								
										SERVICES ENGINEER	Simpson Kotzman	T 03 9663 3030
										BUILDING SURVEYOR	Mackenzie Group Consulting	T 03 9247 0400
										FIRE ENGINEER	WSP Group	T 03 8327 8673
									+			
			_						+	ESD	Simpson Kotzman	T 03 9663 3030
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THE PINES 181 REYNOLDS RD DONCASTER EAST 3109	NORTH, EAST & WEST ELEVATION
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	DATE 10/11/2017	PLOT DATE 10/11/2017	
	SCALE 1:250 @A1 / 1:500 @A3		



E3 EAST ELEVATION
TP100 Scale 1:250



E4 EAST ELEVATION
TP100 Scale 1:250

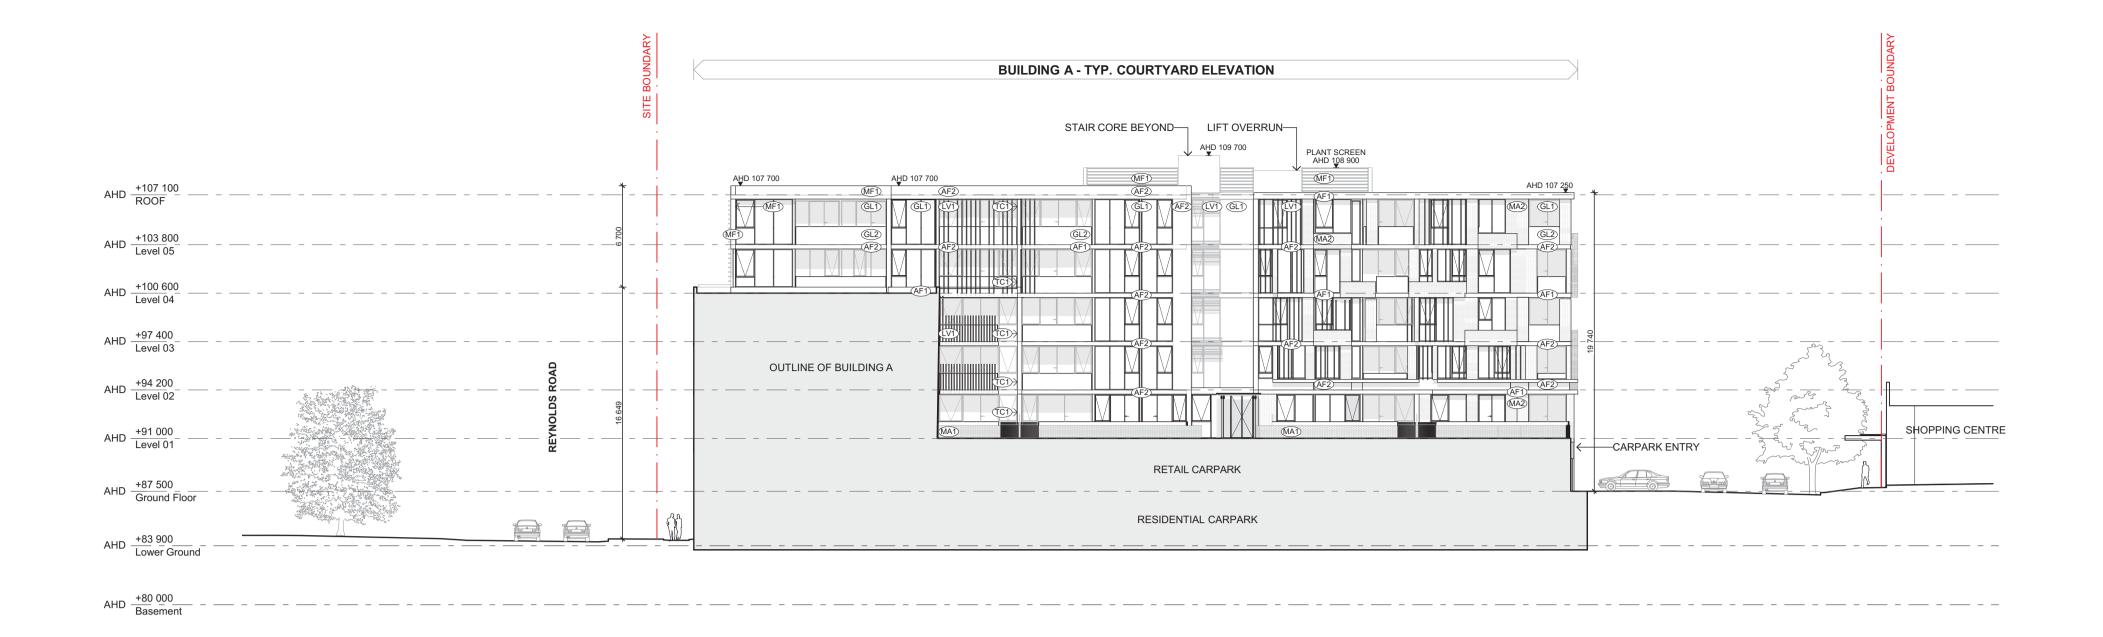MATERIAL LEGEND: REFER 7.01 MATERIAL SCHEDULE

AF2 APPLIED FINISH:

AF2 APPLIED FINISH:

DARK

MF1 METAL FINISH DARK MF2 METAL FINISH MA1 MASONRY LIGHT MA2 MASONRY GL1 GLAZING: CLEAR
GL2 GLASS BALUSTRADE: CLEAR

LV1 SCREENING: LOUVRE DARK

LV2 SCREENING: LOUVRE DARK (CARPARK)

TC1 SOFFITS & WALL: TIMBER LOOK

PB1 PLANTER BOX: DARK FINISH

WALL:
DOK

MP1

METAL POST:
DARK FINISH

BOX:
SH

PS1

PRIVACY SCREENING:
DARK FINISH

FOR TOWN PLANNING


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19.12.17	ISSUED FOR TOWN PLANNING RFI - NO CHANGE	AH	NM	2								
										SERVICES ENGINEER	Simpson Kotzman	T 03 9663 303
										_		
										BUILDING SURVEYOR	Mackenzie Group Consulting	T 03 9247 040
										FIRE ENGINEER	WSP Group	T 03 8327 867
										FIRE ENGINEER	war Group	1 03 0327 001
										ESD	Simpson Kotzman	T 03 9663 303
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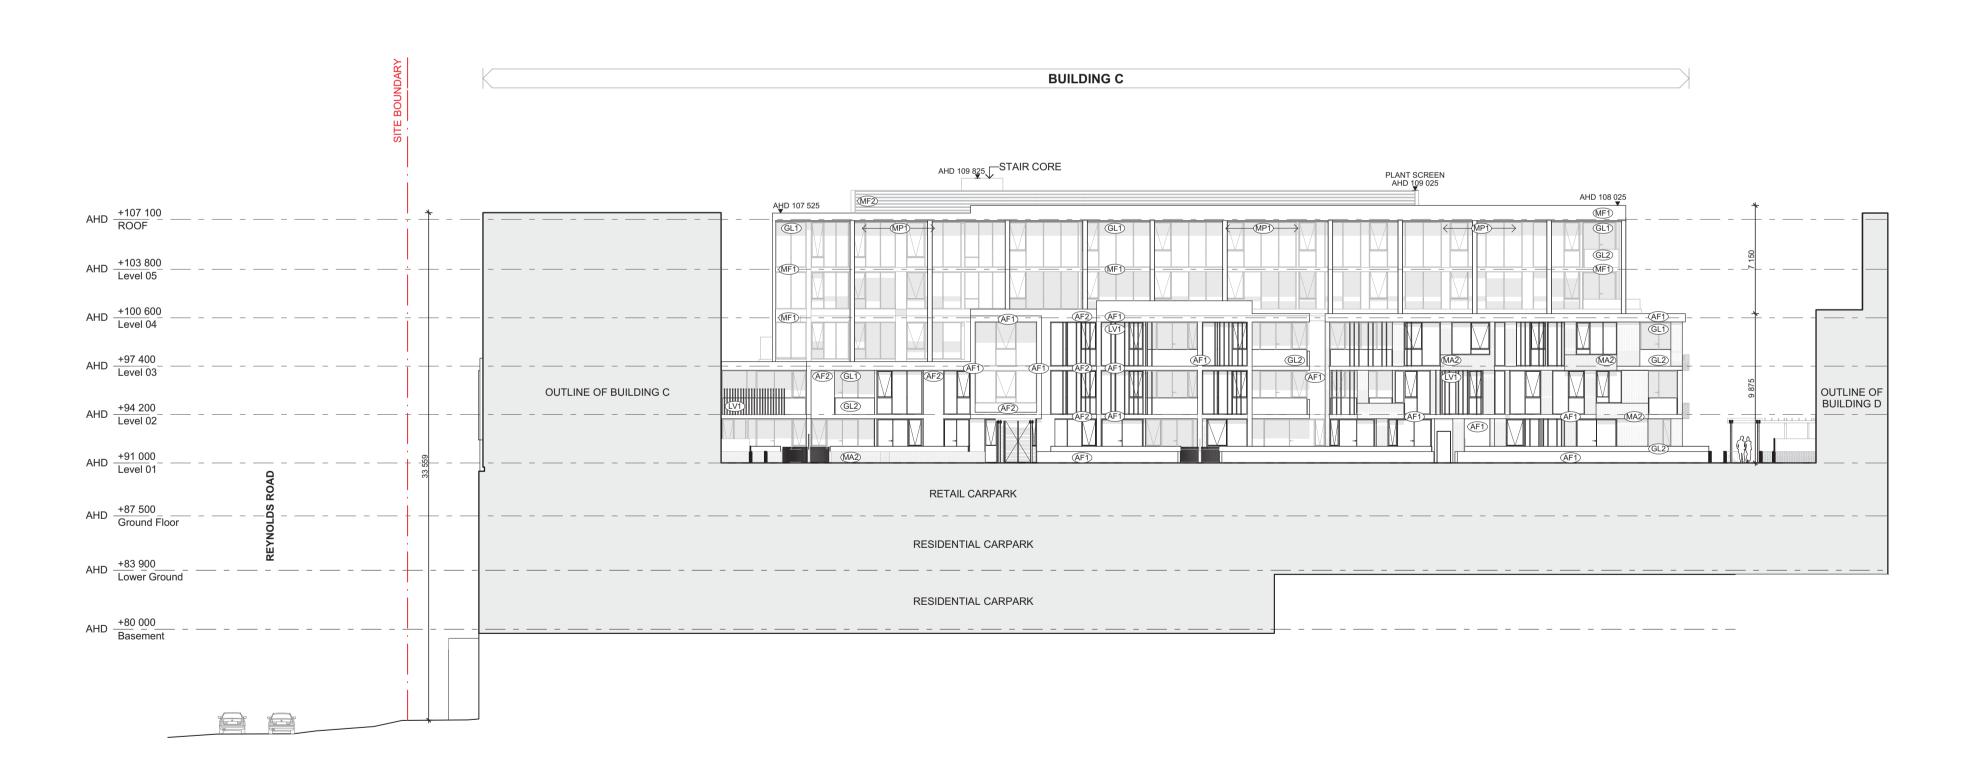


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erty rights. The re all claims against rects without the	JOB NO.	DRAWING NO.	REVISION
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E5 EAST ELEVATION
TP100 Scale 1:250



E6 EAST ELEVATION
TP100 Scale 1:250

MATERIAL LEGEND: REFER 7.01 MATERIAL SCHEDULE

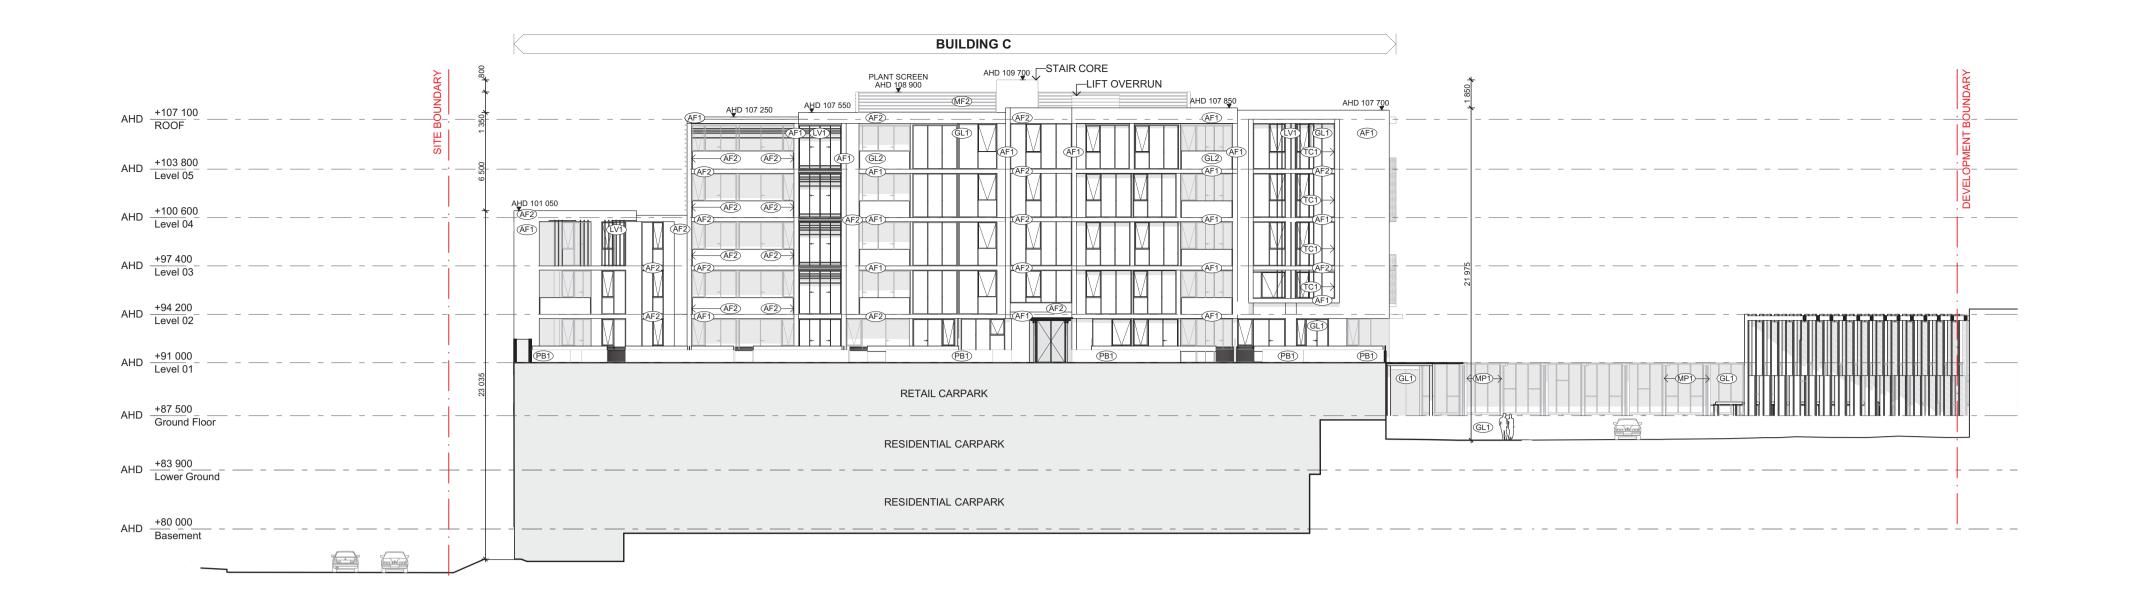AF2 APPLIED FINISH: DARK

MF1 METAL FINISH:
DARK
MF2 METAL FINISH:
LIGHT

GL1 GLAZING: CLEAR GL2 GLASS BALUSTRADE: CLEAR

LV1 SCREENING: LOUVRE DARK SCREENING: LOUVRE DARK (CARPARK)

MP1 METAL POST: DARK FINISH PB1 PLANTER BOX: DARK FINISH PS1 PRIVACY SCREENING: DARK FINISH

FOR TOWN PLANNING

DATE	REVISION	BY	CHK	NO.	DATE	REVISION	BY CHK NO.	CONSULTANTS		
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								SERVICES ENGINEER	Simpson Kotzman	T 03 9663 3030
								BUILDING SURVEYOR	Mackenzie Group Consulting	T 03 9247 0400
								FIRE ENGINEER	WSP Group	T 03 8327 8673
								ESD	Simpson Kotzman	T 03 9663 3030








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e deemed a	12026	TP138	3



W3 WEST ELEVATION

TP100 Scale 1:250

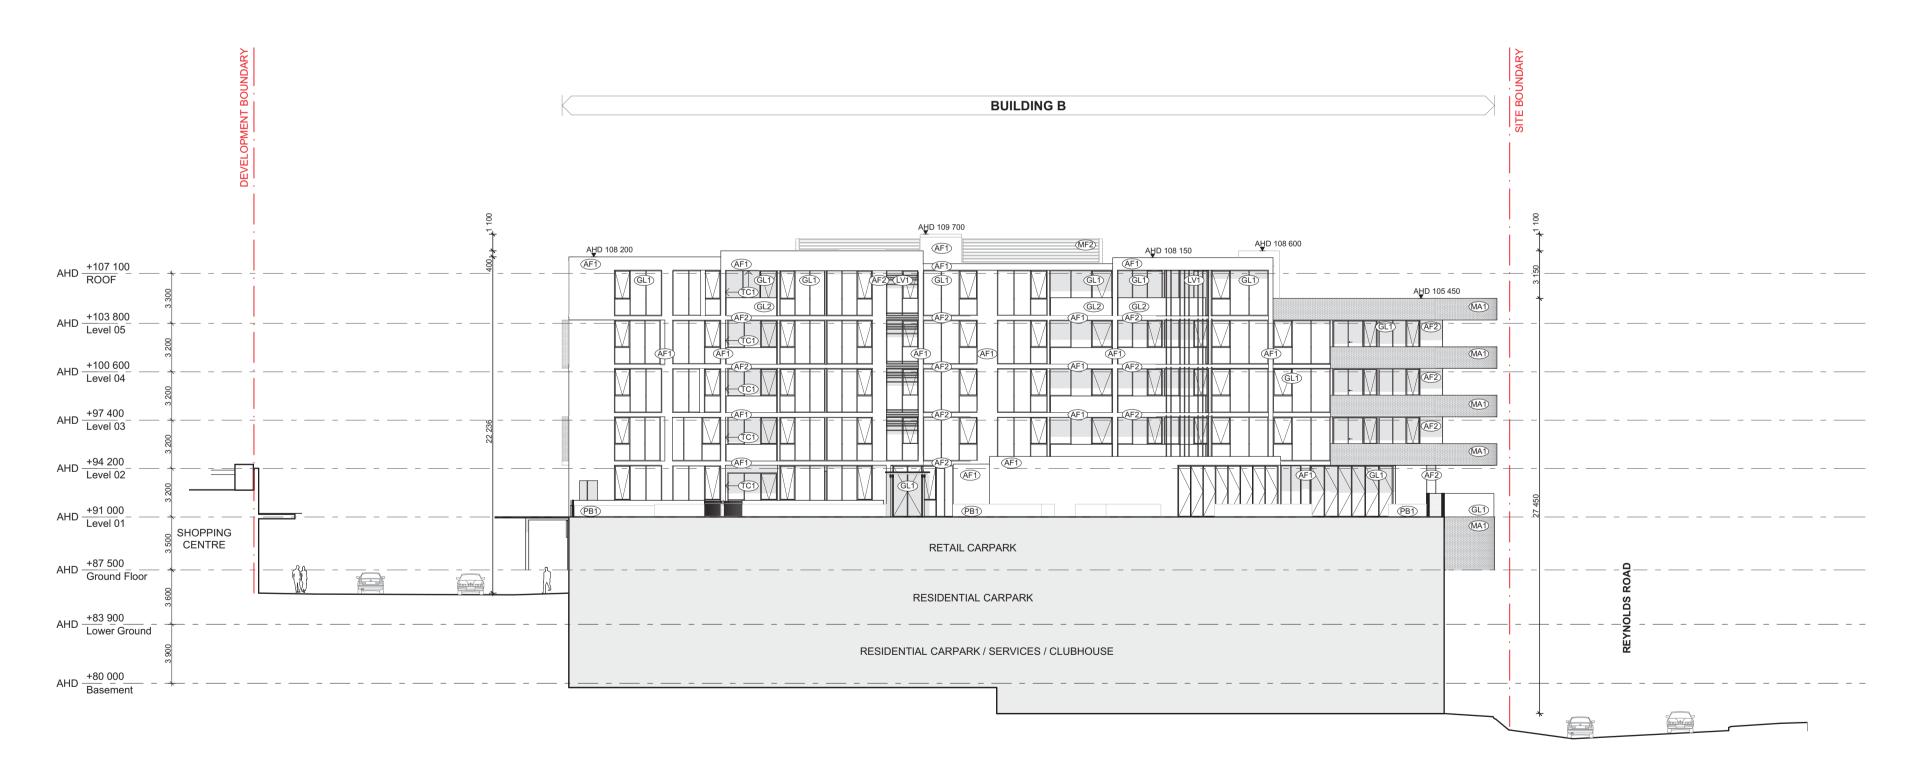

W4 WEST ELEVATION
TP100 Scale 1:250

MATERIAL LEGEND: REFER 7.01 MATERIAL SCHEDULE

AF1) APPLIED FINISH: LIGHT AF2 APPLIED FINISH: DARK MF2 METAL FINISH: LIGHT

GL1 GLAZING: CLEAR GL2 GLASS BALUSTRADE: CLEAR

(LV1) SCREENING: LOUVRE DARK LV2 SCREENING: LOUVRE DARK (CARPARK)

TC1 SOFFITS & WALL: TIMBER LOOK PB1 PLANTER BOX: DARK FINISH

MP1 METAL POST: DARK FINISH PS1 PRIVACY SCREENING: DARK FINISH

FOR TOWN PLANNING

					_						
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										SERVICES ENGINEER	Simpson Kotzman
										BUILDING SURVEYOR	Mackenzie Group Cor
										FIRE ENGINEER	WSP Group
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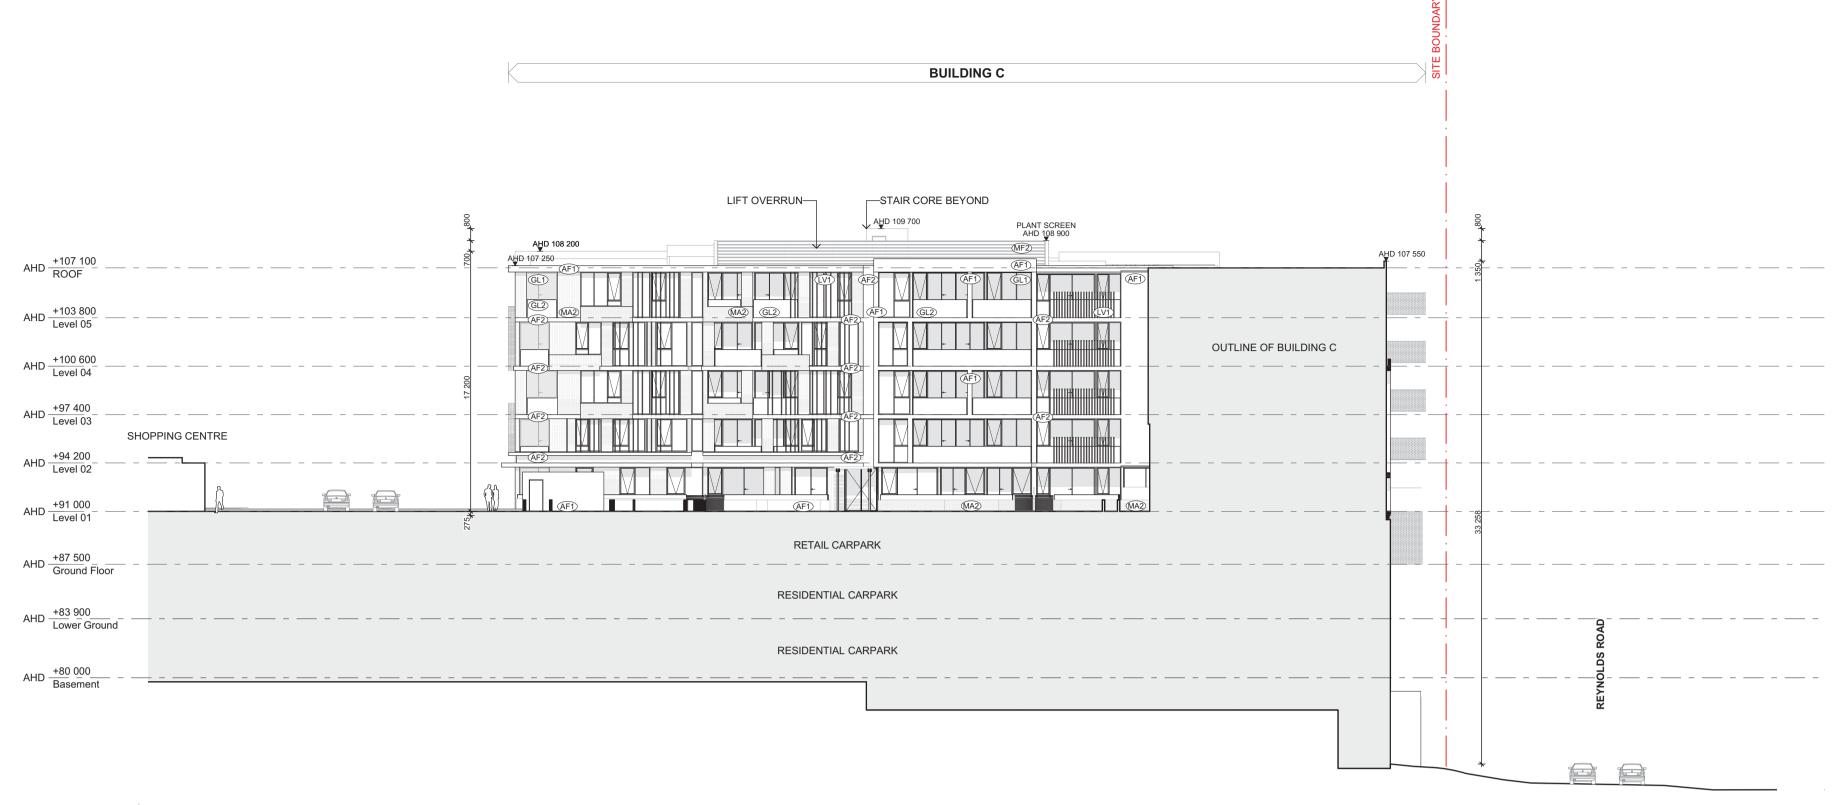





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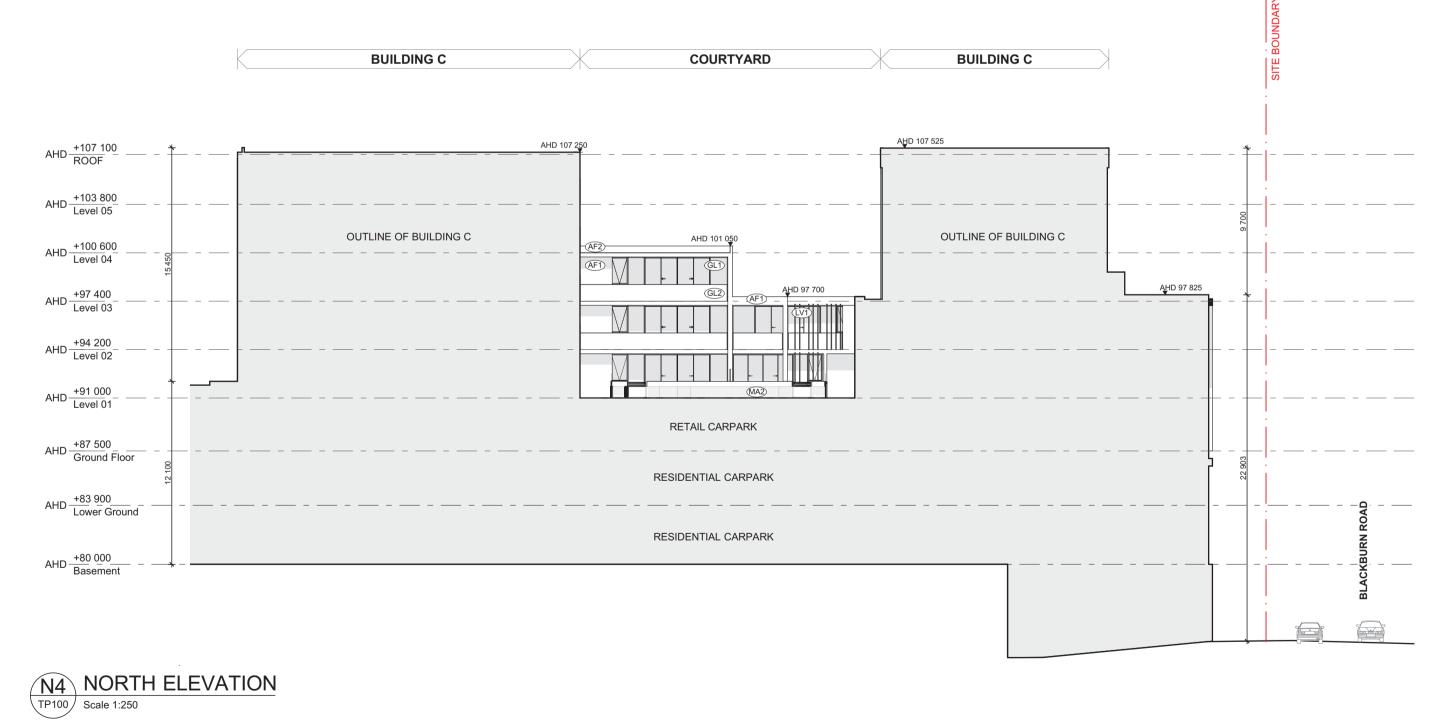
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deemed a	12026	TP139	3



W5 WEST ELEVATION
TP100 Scale 1:250



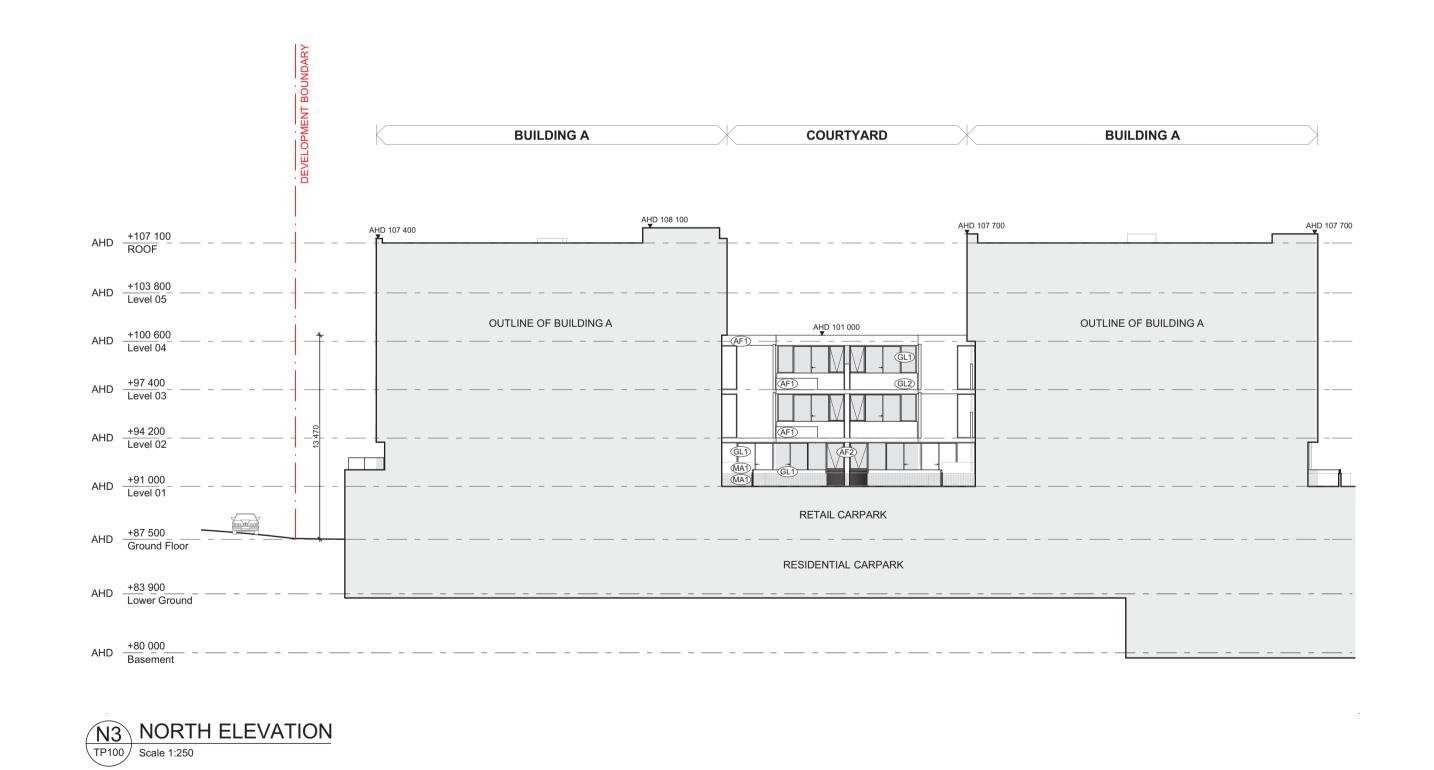

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										BUILDING SURVEYOR	Mackenzie Group Consulting	T 03 9247 0400
										FIRE ENGINEER	WSP Group	T 03 8327 8673
				_						ESD	Simpson Kotzman	T 03 9663 3030



AF1 APPLIED FINISH: LIGHT

AF2 APPLIED FINISH: DARK

MATERIAL LEGEND: REFER 7.01 MATERIAL SCHEDULE

MF1 METAL FINISH:
DARK
MF2 METAL FINISH:
LIGHT



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GL1 GLAZING: CLEAR
GL2 GLASS BALUSTRADE: CLEAR

DJECT HE PINES	DRAWING TITLE WEST & NORTH
1 REYNOLDS RD DNCASTER EAST 09	ELEVATION (INTERNAL)
conting and utilizing this decument the	recipient agrees that Plus Architecture Ptv Ltd. ACN 0016003

SCREENING: LOUVRE DARK

LV2 SCREENING: LOUVRE DARK (CARPARK)

	WEST & NORTH	1:250 @A1 / 1:500 @A3		
	ELEVATION (INTERNAL)	DATE 10/11/2017	PLOT DATE 10/11/2017	
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			l	l

SOFFITS & WALL: TIMBER LOOK


PB1 PLANTER BOX: DARK FINISH

FOR TOWN PLANNING

MP1 METAL POST: DARK FINISH

PS1 PRIVACY SCREENING: DARK FINISH



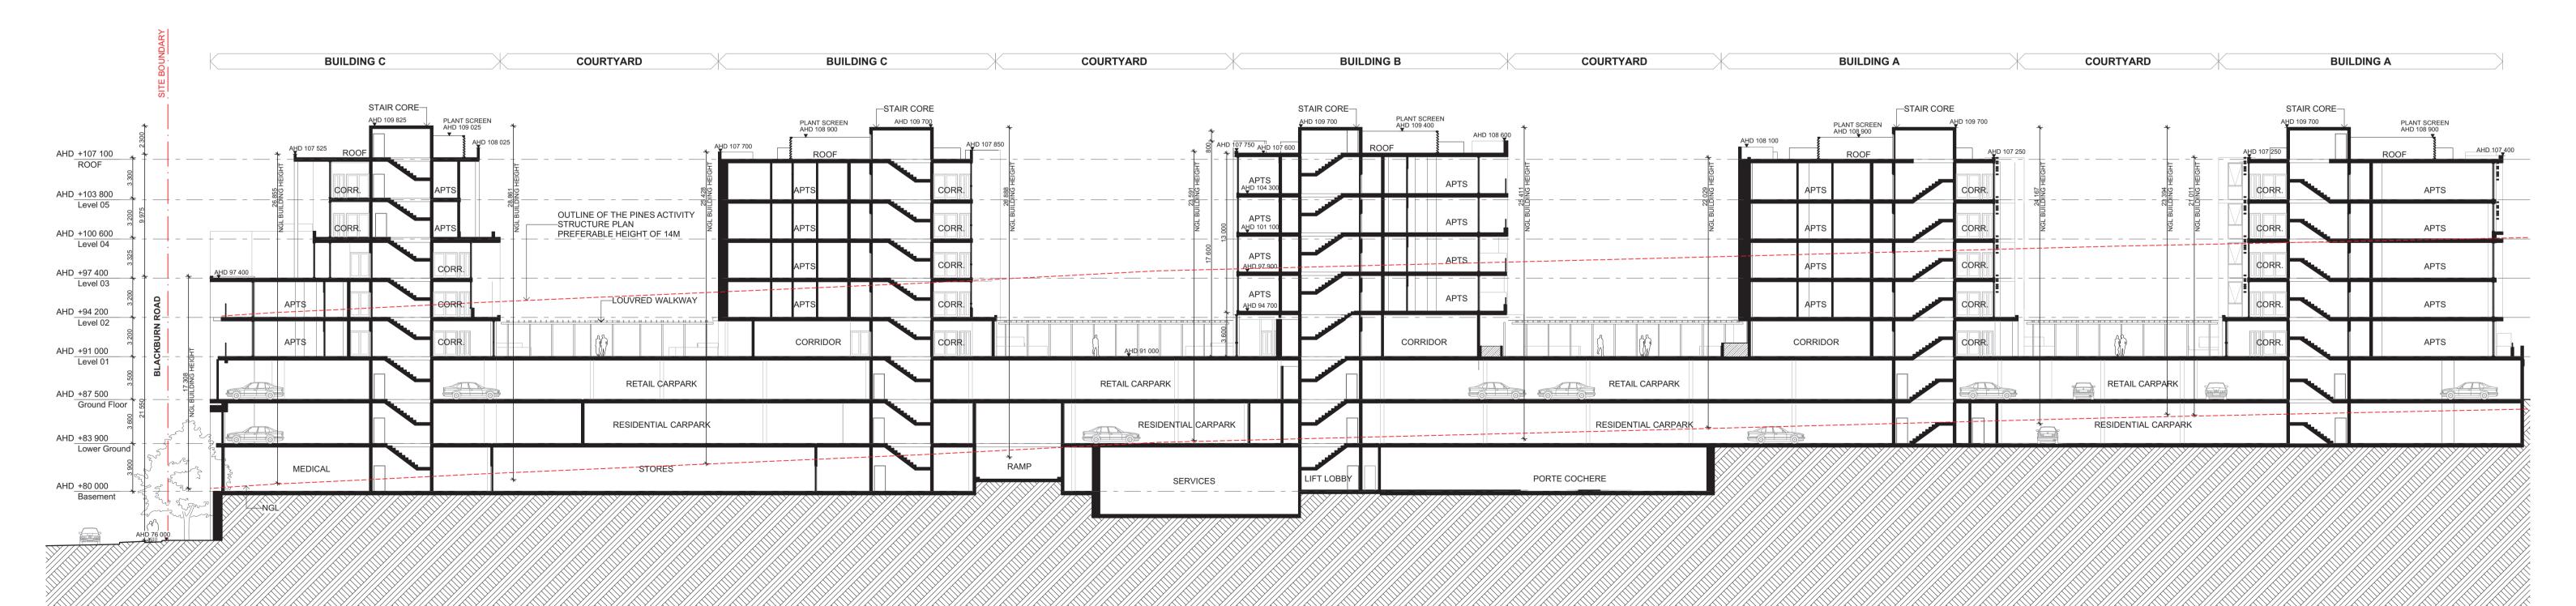

T 03 9418 4000

T 03 9663 3030

T 03 9247 0400

T 03 8327 8673

T 03 9663 3030

CONSULTANTS REVISION BY CHK NO. DATE 10.11.17 ISSUED FOR TOWN PLANNING ISSUED FOR TOWN PLANNING RFI SERVICES ENGINEER Simpson Kotzman Mackenzie Group Consulting

FIRE ENGINEER

Simpson Kotzman

B SECTION

TP100 Scale 1:250


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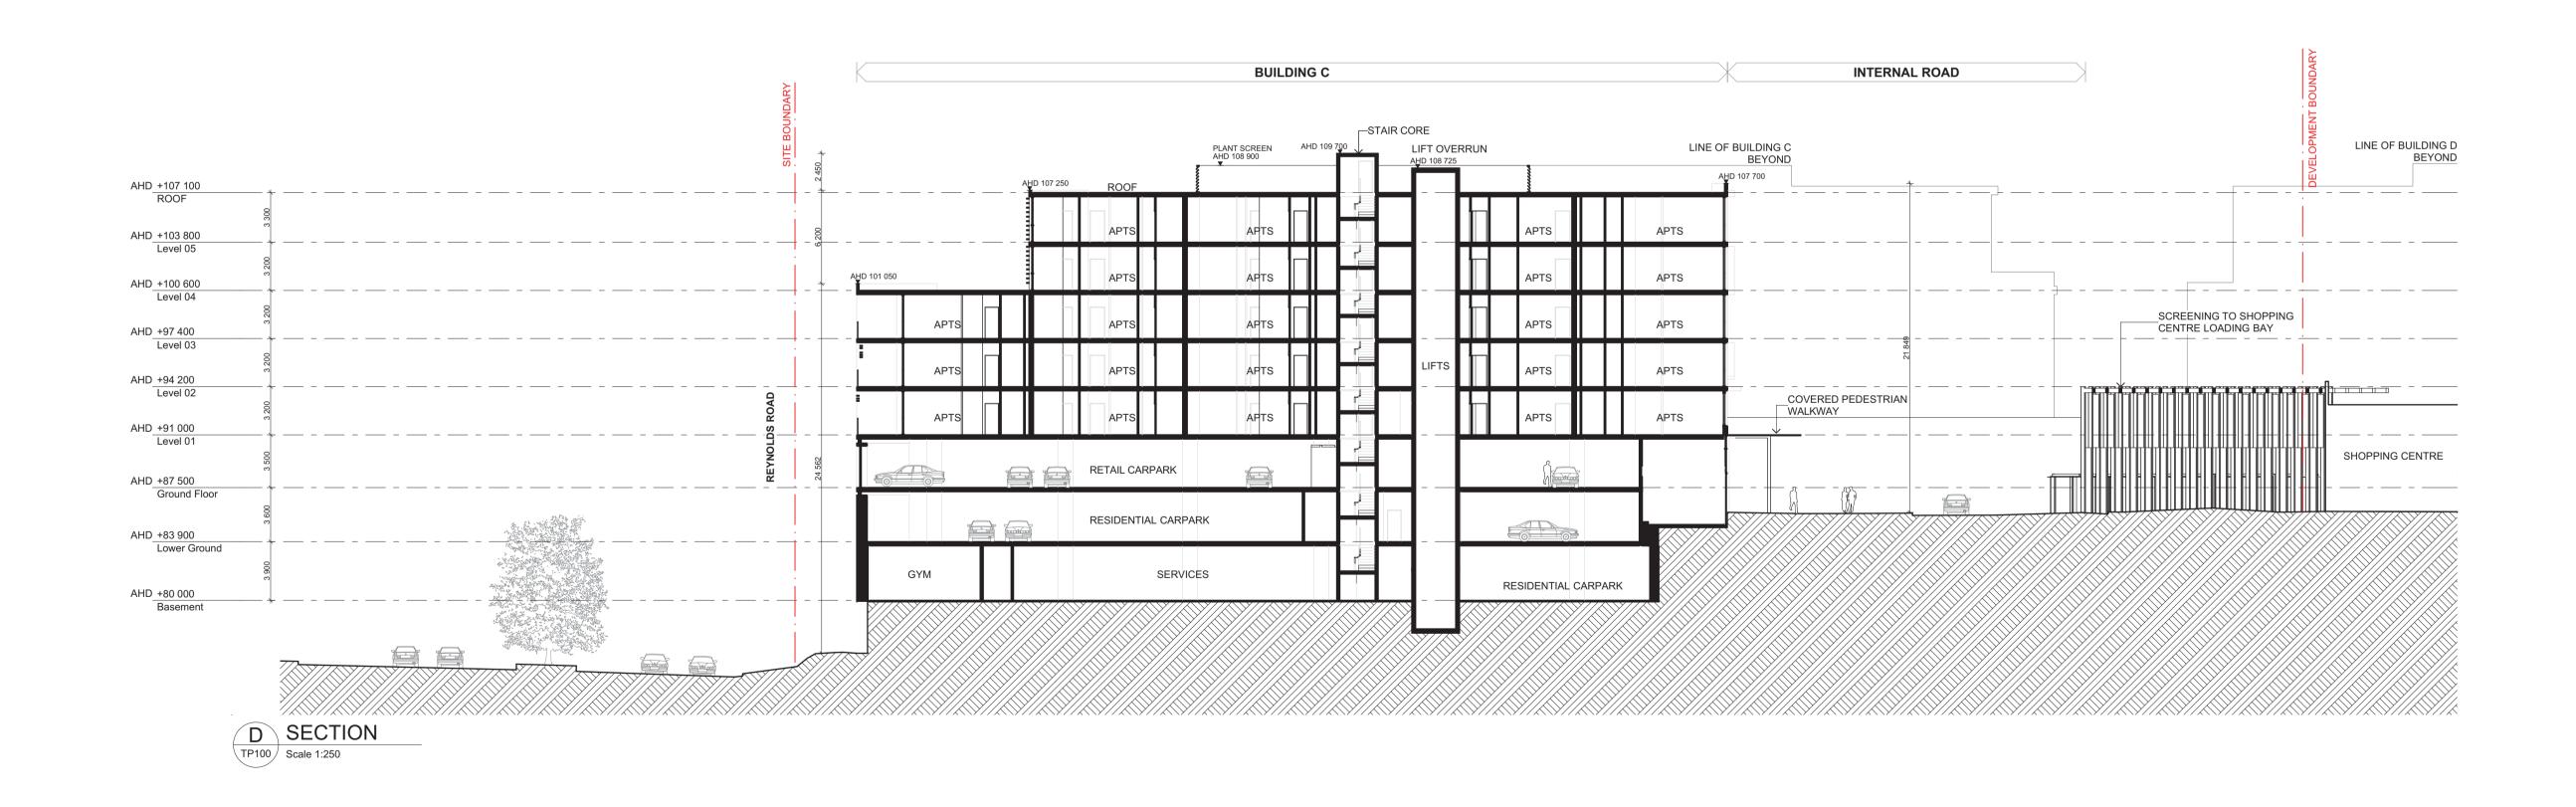




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PROJECT THE PINES	DRAWING TITLE SECTIONS	SCALE 1:250 @A1 / 1:500 @A3		
181 REYNOLDS RD DONCASTER EAST		DATE 10/11/2017	PLOT DATE 10/11/2017	
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FOR TOWN PLANNING PROJECT DRAWING TITLE SCALE





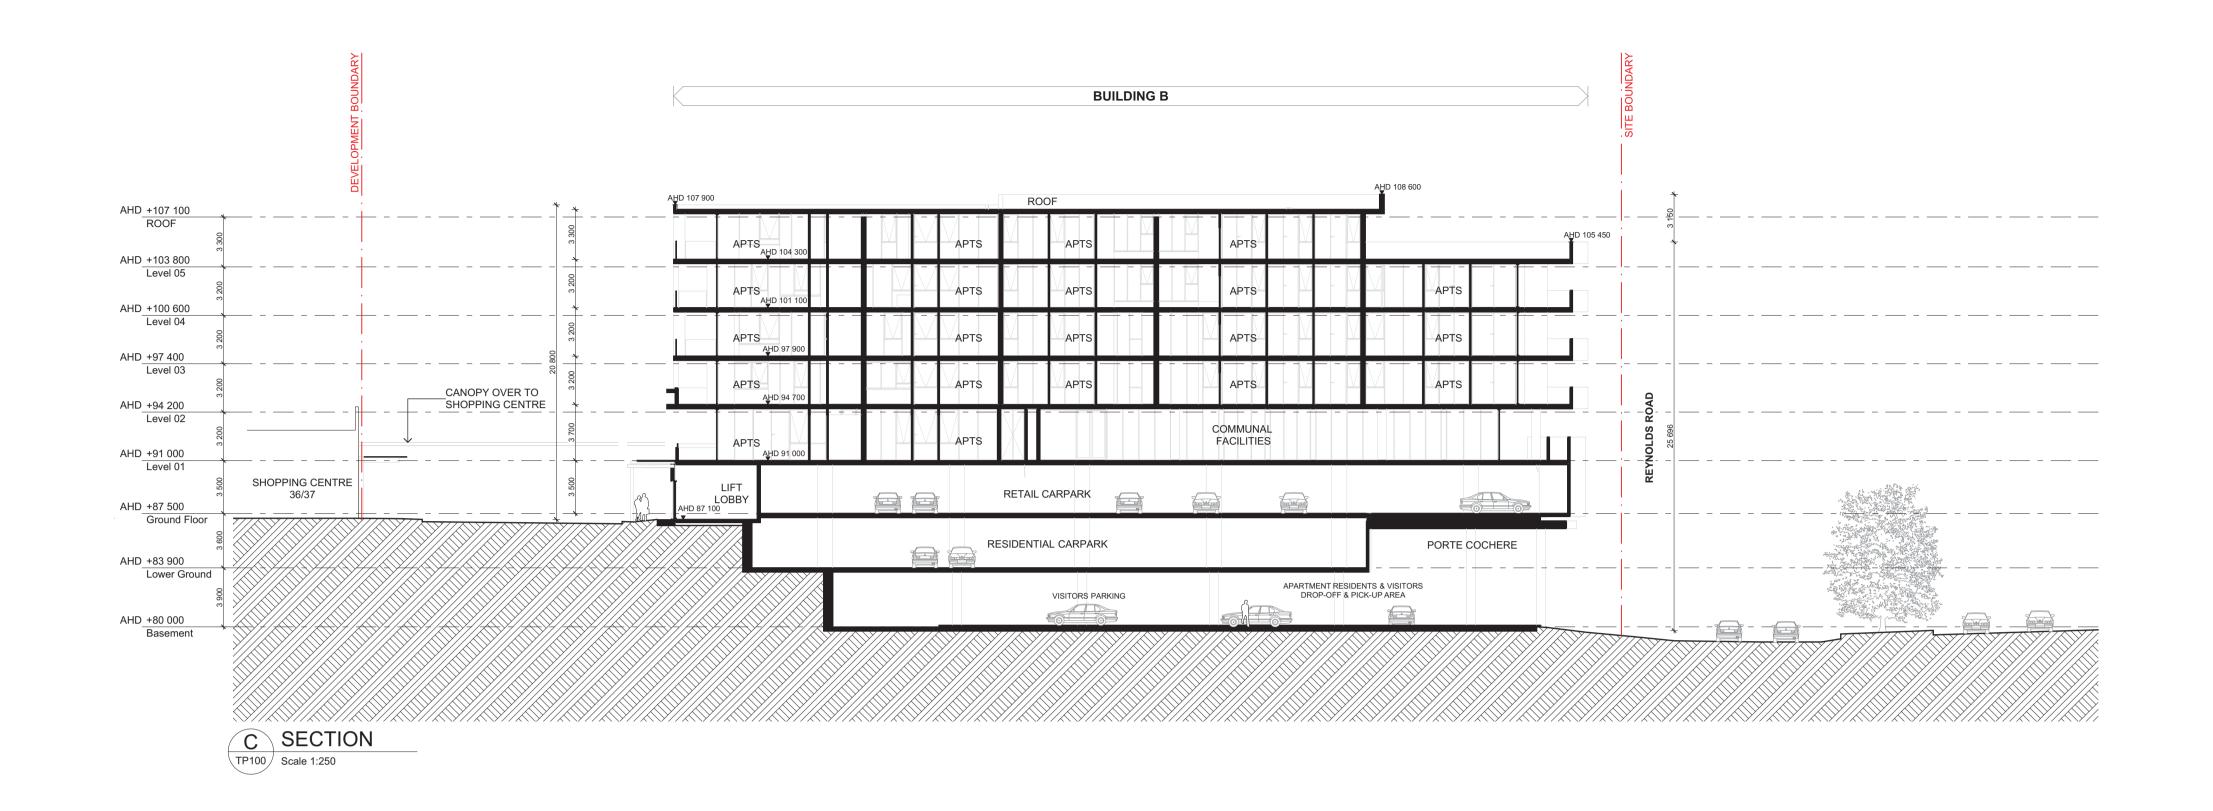



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w Zealand	In accepting and un retain all common la recipient agrees no		
3 8696 3999 urchitecture	Plus Architecture re prior written conse		

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THE PINES	SECTIONS
181 REYNOLDS RD	
DONCASTER EAST	
3109	
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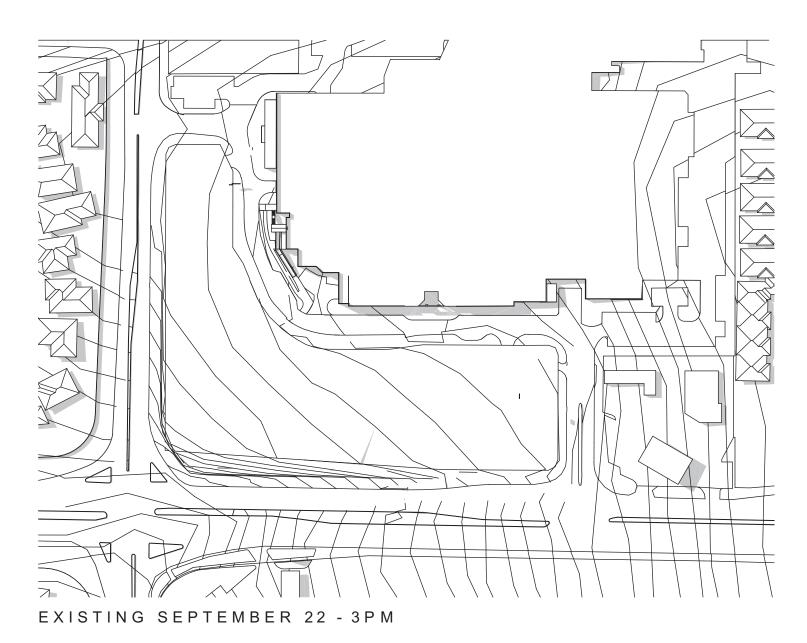
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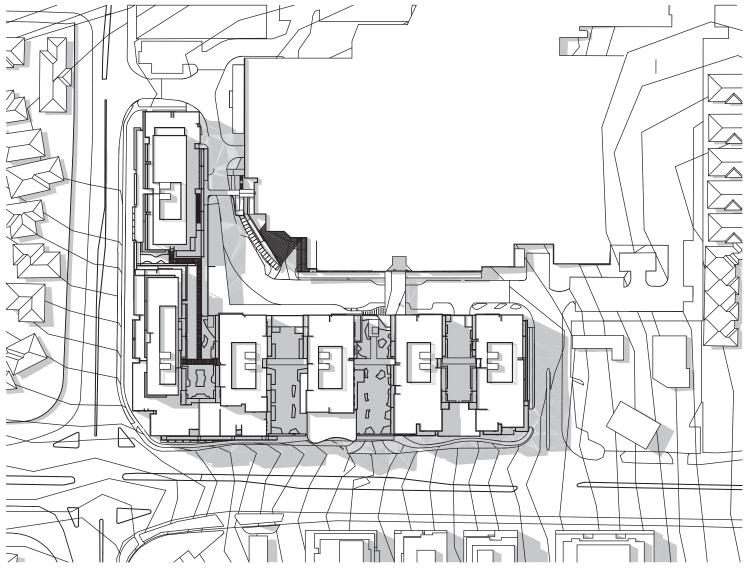




PROPOSED SEPTEMBER 22 - 9AM

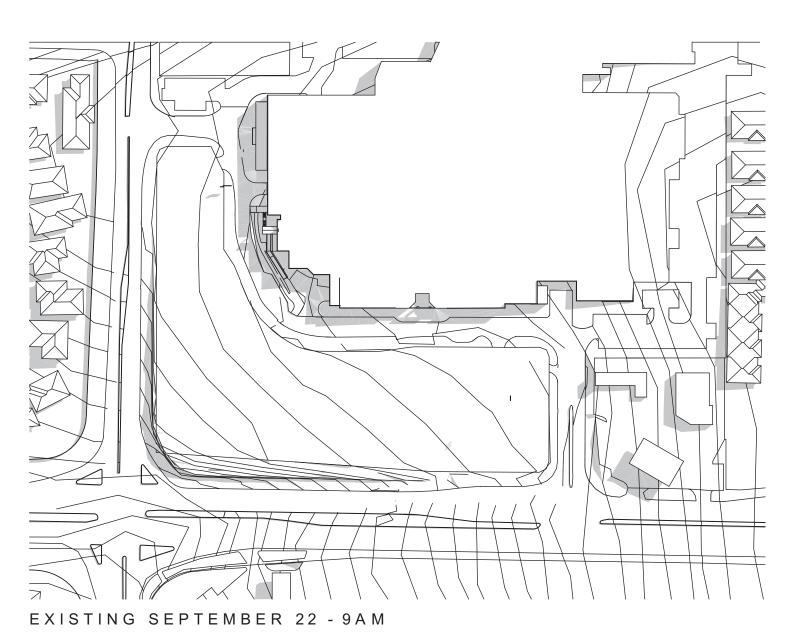

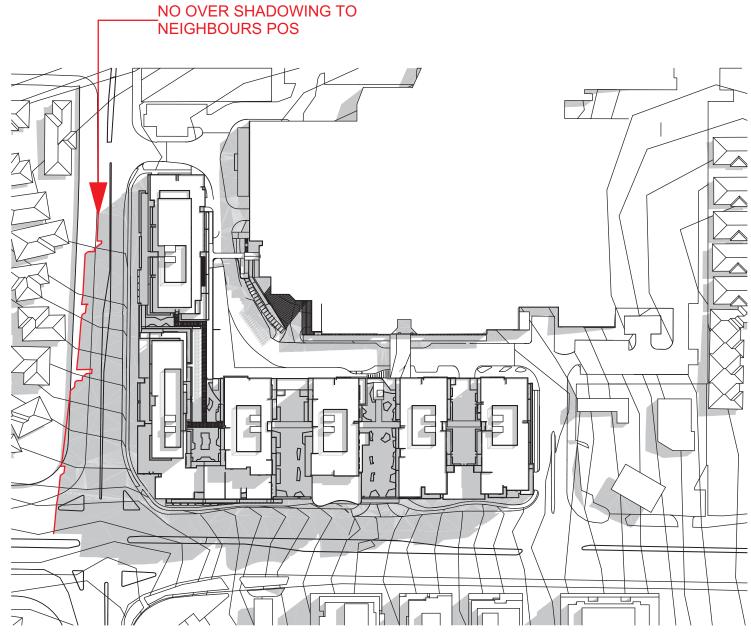




PROPOSED SEPTEMBER 22 - 3PM




MATERIAL SCHEDULE

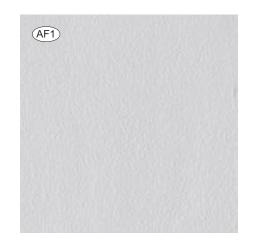







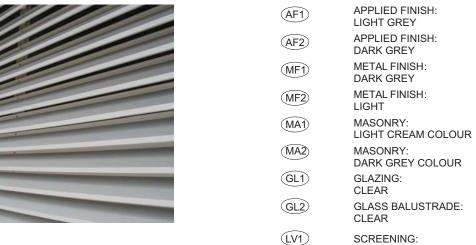












PLANTERBOX: DARK GREY FINISH


VERTICAL/HORIZONTAL ALUMIMIUN LOUVRE




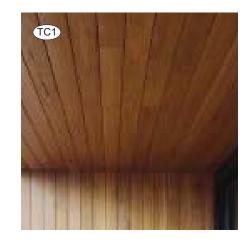



NO:12026 DATE: 11/01/2018 REVISION: 3

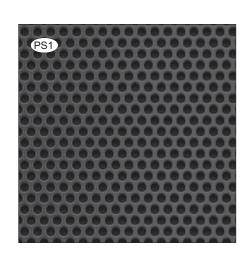

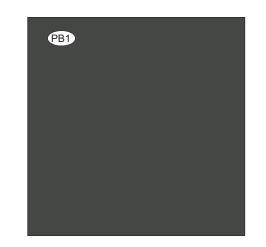

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THE PINES - COURTYARD LANDSCAPE CONCEPT 1:250 @ A1 DWG NO: L1000 REV: G














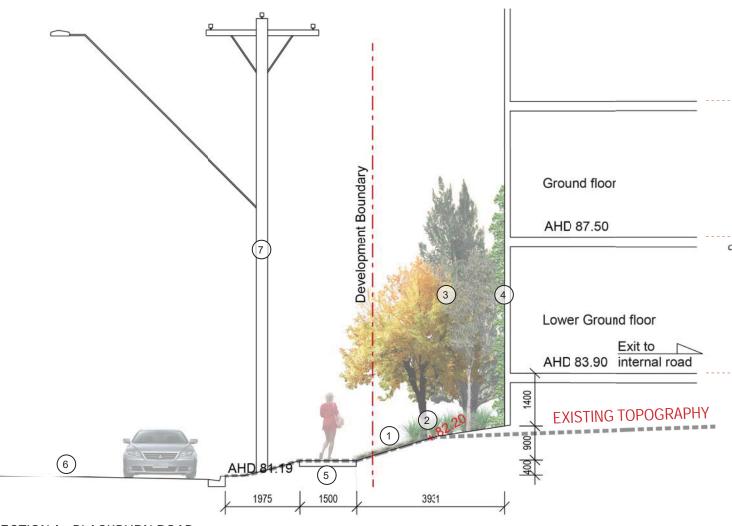

SECTION A - BLACKBURN ROAD

- 1. Mass planting of native ground covers and wild flowers to the area adjacent to the existing footpath.
- 2. Mass planting of layered understorey including native shrubs and grasses.
- 3. Mixed planting of small to medium sized indigenous tree species such as Wattles, Black Sheoak and White Cypress to landscape buffer between the public footpath and the building's edge/facade.
- 4. Wire mesh trellis to be attached to the building's facade / retaining wall which facilitates a living 'green wall' of native climbing species planted in the landscape buffer beneath.
- 5. Existing footpath.
- 6. Blackburn Road.
- 7. Utility pole in nature strip.



KEY PLAN







1. Mass planting of native ground covers and wild flowers to the area adjacent to the existing footpath.

1500

2. Mass planting of layered understorey including native shrubs and grasses.

1763

- 3. Mixed planting of small to medium sized indigenous tree species such as Wattles, Black Sheoak and White Cypress to landscape buffer between the public footpath and the building's edge/facade.
- 4. Wire mesh trellis to be attached to the building's facade / retaining wall which facilitates a living 'green wall' of native climbing species planted in the landscape buffer beneath.

AHD 76.00

4718

- 5. Larger canopy trees (such as Eucalypts) to be planted throughout the landscape buffer at points where there are more space.
- 6. Existing footpath.
- 7. Blackburn Road.
- 8. Utility pole in nature strip.

THE PINES - BLACKBURN ROAD SECTIONS 1:100 @ A3

Ground floor


AHD 87.50

AHD 83.90

Lower Ground floor


Exit to internal road

EXISTING TOPOGRAPHY

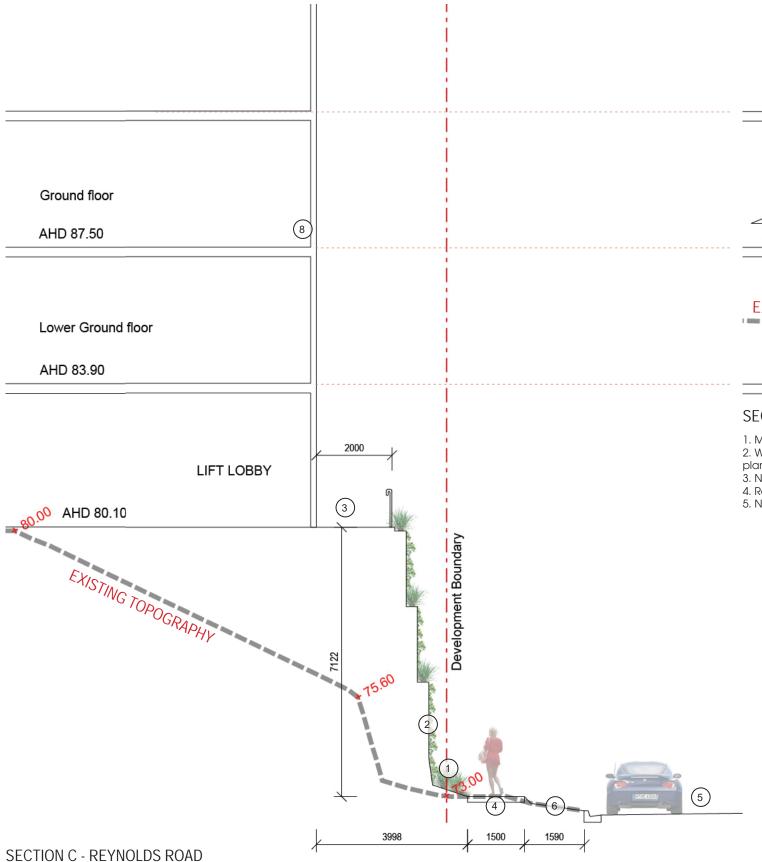


- 1. Mass planting of native ground covers and wild flowers to the area adjacent to the existing footpath.
- 2. Wire mesh trellis to be attached to the external ramp frame which facilitates a living 'green wall' of native climbing species planted in the landscape buffer beneath.
- 3. External ramp access to Lift Lobby from the building exterior (refer to Architectural drawings).
- 4. Existing footpath.
- 5. Reynolds Road.
- 6. Existing nature strip



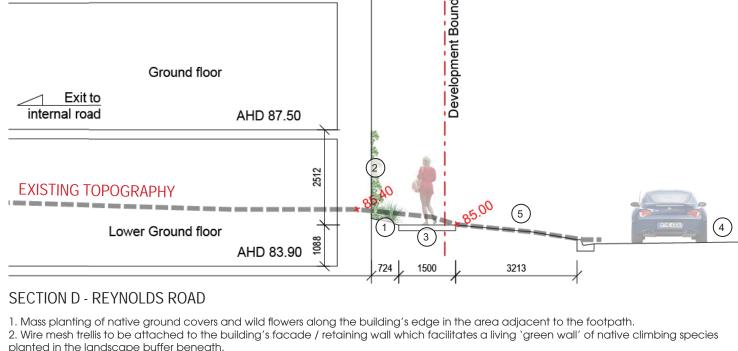

- planted in the landscape buffer beneath.
- 3. New footpath.
- 4. Reynolds Road.
- 5. Nature strip.

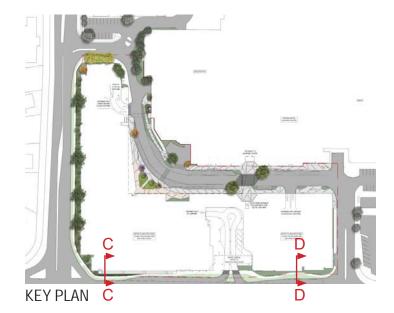

THE PINES - REYNOLDS ROAD SECTIONS



TYPICAL ELEVATION A - GREEN WALL TREATMENT SYSTEMS TO BUILDING FACADE AND RETAINING WALLS.

- 1. Tensile wire to recessed areas of building facade or retaining wall with assisted climbing vine species .
- Self supporting creeping plant species (such as Ficus pumila).
 Tensile wire system set out in a grid format and attached to building facade / retaining wall face to assist climbing plant species.






PUBLIC REALM PLANT SELECTION

CODE	BOTANICAL NAME	COMMON NAME	MATURE HEIGHT x WIDTH (M)	POT SIZE
	TREES	1		
	Acacia dealbata	Silver Wattle	30.0 x 10.0	200L
	Acacia melanoxylon	Blackwood	8.0-20.0 x 8.0-10.0	200L
	Corymbia maculata	Spotted Gum	30.0 x 10.0	200L
	Eucalyptus radiata	Narrow-leaved Peppermint	10.0-20.0 x 6.0-15.0	200L
SMAI	L/MEDIUM TREES	Numow leaves repermine	10.0 20.0 X 0.0 13.0	2001
JIVIAL	Acacia implexa	Lightwood	6.0 tall	100L
	Acacia pycnantha	Golden Wattle	3.0-6.0 tall	100L
	Allocasuarina littoralis	Black Sheoak	4.0-12.0 x 2.0-5.0	100L
	Callitris columellaris	White Cypress	12.0 x 2.0	100L
	Jacaranda mimosifolia	Jacaranda	15.0 x 8.0	100L
	Melia azedarach 'Elite'	White Cedar	15.0 x 8.0	100L
	Olearia lirata	Snow Daisy-bush	2.0-3.0 x 1.0	100L
	Pistacia chinensis	Chinese Pistache		
	<u> </u>		8.0 x 6.0	100L
CD 4 4 1	Pyrus calleryana 'Chanticleer'	Ornamental Pear	11.0 x 6.0	100L
SIVIAL	L/MEDIUM SHRUBS	Coll Latavanta	15.40	751
	Acacia acinacea	Gold-dust Wattle	1.5 x 1.0	75L
	Acacia genistifolia	Spreading Wattle	1.0-2.0 x 1.0	75L
	Acacia myrtifolia	Myrtle Wattle	1.5-2.0 x 1.0	75L
	Coprosma quadrifida	Prickly Currant-bush	2.0-3.0 x 1.0-1.5	75L
	Correa reflexa	Correa	0.5-1.0 x 0.5-1.0	75L
	Epacris impressa	Common Heath	1.5 tall	75L
	Goodia lotifolia	Golden Tip	1.0-3.0 x 1.0-2.0	75L
	Goodenia ovata	Hop Goodenia	1.0-1.5 x 1.0-1.5	75L
	Indigofera australis	Austral Indigo	1.0-2.0 x 1.0	75L
	Leptospermum scoparium	Manuka	2.0-3.0 tall	75L
	Lythrum salicaria	Purple Loosestrife	1.0-2.0 x 1.0	75L
	Pultenaea gunnii	Golden Bush-pea	1.0 x 0.75-1.0	75L
	Spyridium parvifolium	Dusty Miller	1.0-2.0 tall	75L
GROU	ND COVERS			
	Billardiera mutablis	Common Apple-berry	spreading	tubrstock
	Dichondra repens	Kidney-weed	spreading	tubrstock
	Hedera canariensis	Canary Islands Ivy	spreading/climbing	tubestock
	Kennedia prostrata	Running Postman	spreading	tubrstock
	Pratia pedunculata	Matted Pratia	spreading	tubrstock
	Viola hederacea	Ivy-leaf Violet	spreading	tubrstock
CLIME	BERS			
	Clematis aristata	Mountain Clematis	spreading/climbing	150mm
	Convolvulus erubescens	Pink Bindweed	spreading/climbing	150mm
	Hardenbergia violacea	Purple Coral-pea	spreading/climbing	150mm
	Pandorea pandorana	Wonga Vine	spreading/climbing	150mm
GRAS	SES			
	Austrodanthonia species	Wallaby-grasses	varies	150mm
	Austrostipa rudis	Veined Spear-grass	1.0-1.5 tall	150mm
	Blechnum nudum	Fishbone Water-fern	1.0 x 1.0	300mm
	Clivia miniata	Kaffir Lily	0.3-0.6 x 0.3-0.6	300mm
	Doodia aspera	Prickly Rasp Fern	0.4 x 0.6	300mm
	Microlaena stipoides	Weeping Grass	0.1 x running	150mm
	Poa labillardierei	Common Tussock-grass	0.7 x 0.75	150mm
	Themeda triandra	Kangaroo Grass	0.5 x 0.5	150mm
WILD	FLOWERS	, , , , , , , , , , , , , , , , , , ,		
	Arthropodium strictum	Chocolate Lily	0.2-1.0 x 0.2-0.8	tubrstock
	Bulbine bulbosa	Bulbine Lily	0.25 x 0.3	tubrstock
	Dianella species	Flax-lilies	varies	tubrstock
	Helichrysum scorpioides	Button Everlasting	0.3 x 0.2-0.3	tubrstock
	Lomandra longifolia	Spiny-headed Mat-rush	1.0 x 1.0	tubrstock
	Stylidium armeria	Grass Trigger-plant	0.2-1.1 x 0.2-0.3	tubrstock
	Tetratheca ciliata	Pink-bells	0.2-1.1 x 0.2-0.3 0.5 tall	+
				tubrstock
l	Xerochrysum viscosum	Sticky Everlasting	0.5 x 0.75	tubrstock

TREES



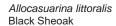



Acacia pycnantha Golden Wattle



Callistris columellaris White Cypress



Eucalyptus radiata Narrow-leaved Peppermint



Olearia lirata Snow Daisy-bush



Acacia melanoxylon Blackwood



Jacaranda mimosifolia Jacaranda



Pistacia chinensis Chinese Pistache

UNDERSTOREY PLANTING





Clematis aristata



Correa reflexa Correa



Austrostipa rudis Veined Spear-grass



Tetratheca ciliata Pink-bells



Billardiera mutablis Common Apple-berry



Hardenbergia violacea Purple Coral-pea



Pultenaea gunnii Golden Bush-pea



Kangaroo Grass



Bulbine bulbosa **Bulbine Lily**



Kennedia prostrata Running Postman



Pandorea pandorana Wonga Vine



Lythrum salicaria Purple Loosestrife



Poa labillardierei Common Tussock-grass



Stylidium armeria Grass Trigger-plant



Viola hederacea Ivy-leaf Violet





PRIVATE REALM PLANT SELECTION

CODE	BOTANICAL NAME	COMMON NAME	MATURE HEIGHT x WIDTH (M)	POT SIZE
	L/MEDIUM TREES	-		
	Acer palmatum 'Osakazuki'	Japanese Maple	5.0 x 4.0	100L
	Lagerstroemia indica x L.fauriei 'Biloxi'	Crepe Myrtle	7.0 x 5.0	100L
	Lagerstroemia indica x L.fauriei 'Lipan'	Crepe Myrtle	4.0 x 3.0	100L
	Lagerstroemia indica x L.fauriei 'Zuni'	Crepe Myrtle	3.0-4.0 x 3.0	100L
	Olea europaea 'Kalamata'	Olive Tree	6.0 x 3.0	100L
MAL	L FRUIT TREES	-	-	
	Citrus limon	Lemon Lemonade - Citrange	2.0 x 2.0	45L
	Citrus sinensis	Washington Navel - Flying Dragon	2.0 x 2.0	45L
	Diospyros kaki 'Fuyu'	Persimmon 'Fuyu'	6.0 x 5.0	45L
	Ficus carica 'St Dominique Violette'	Fig St Dominique Violette	3.0 x 4.0	45L
	Malus domestica	Dwarf Apple Cripps Pink	3.0 x 2.0	45L
	Malus domestica 'Jonathan'	Dwarf Apple Jonathan	3.0 x 2.0	45L
	Persea americana	Avocado Pinkerton	4.0 x 4.0	45L
	Prunus domestica 'Mount Royal'	Mount Royal Plum	3.0-6.0 x 1.5-3.0	45L
	Pyrus communis 'Beurre Bosc'	Pear Beurre Bosc	6.0 x 4.0	45L
	Pvrus communis 'Faccia Rosa'	Cocktail Pear Facia Rosa	3.0 x 3.0	45L
ΙΔΜΖ	L/MEDIUM SHRUBS	cocken real radia Rosa	3.6 X 3.6	132
,,,,,,,	Correa 'Dusky Bells'	Dusky Bells	1.0 x 2.0-4.0	300mm
	Crowea exalata	Crowea	0.7 x 1.0	300mm
	Choisya ternata	Mock Orange	2.0 x 2.0	300mm
	Grevillea sericea	Pink Spider Flower	0.5-1.2 x 2.0-3.0	300mm
	Indigofera australis	Austral Indigo	1.0-2.0 x 1.0-2.0	300mm
	Microcitrus australasica	Finger Lime	3.0 x 2.0	300mm
	Pieris japonica	Japanese andromeda	2.5 x 1.5	300mm
	Banksia spinulosa	Hairpin Banksia	1.0-3.0 x 2.0	300mm
	Correa bauerlenii	Chef's Hat Correa	2.0 x 2.0	300mm
	Lambertia formosa	Mountain Devil	1.0-2.0 x 2.0	300mm
	Lomatia silaifolia		1.0-2.0 x 2.0 1.0-2.0 x 1.0	300mm
	Philotheca myoporoides	Crinkle Bush White Wax Flower	0.8-1.0 x 0.8-1.0	300mm
			2.0 x 1.5	300mm
	Vaccinium corymbosum	Blueberry Northland	2.0 x 1.5 4.0 x 2.0	300mm
CDOL	Westringia fruticosa JND COVERS	Native Rosemary	4.0 x 2.0	300111111
JKU	Dichondra argentea 'Silver Falls'	Cil. on Danie fact	0.45.0.22.0.2.0	4
	-	Silver Pony-foot	0.15-0.3 x 2.0-3.0	tubestoc
	Grevillea juniperina	Prostrate forms	0.4 x 2.5 0.4 x 0.4	tubestocl
	Pelargonium rodneyanum	Magenta Storksbill		tubestoc
	Scaevola aemula	Purple Fan Flower	0.6 x 0.4-1.0	tubestoc
	Viola hederacea	Native Violet	0.2 x 0.3	tubestoc
CLIIVI	BERS	A I . D		450
	Billardiera scandens	Apple Berry	spreading/climbing	150mm
	Clematis aristata	Mountain Clematis	spreading/climbing	150mm
	Convolvulus erubescens	Pink Bindweed	spreading/climbing	150mm
	Ficus pumila	Creeping Fig	spreading/climbing	150mm
	Hardenbergia violacea	Purple Coral-pea	spreading/climbing	150mm
	Pandorea pandorana	Wonga Vine	spreading/climbing	150mm
	Parthenocissus quinquefolia	Virginia Creeper	spreading/climbing	150mm
	Parthenocissus tricuspidata	Japanese Ivy	spreading/climbing	150mm
	Wisteria sinensis	Chinese wisteria	spreading/climbing	150mm
GRAS			1	
	Clivia minata	Kaffir Lily	0.5 x 1.0	tubestoc
	Doodia aspera	Prickly Rasp Fern	0.4 x 0.6	tubestoc
	Dianella caerulea	Flax Lily	0.5 x 0.5	tubestoc
	Hosta spp.	Hosta	0.5 x 1.0	tubestocl
	Monstera deliciosa	Fruit Salad Plant	3.0 x 1.0	tubestoc
	Philodendron xanadu	Xanadu	1.5 x 2.0	tubestoc

TREES



Acer palmatum 'Osakazuki' Japanese Maple



Citris limon Lemon Lemonade - Citrange



Diospyros kaki 'Fuyu' Persimmon 'Fuyu'



Lagerstroemia indica x L.fauriei 'Biloxi' Crepe Myrtle



Lagerstroemia indica x L.fauriei 'Lipan' Crepe Myrtle



Olea europaea 'Kalamata' Olive Tree



Prunus domestica 'Mount Royal' Mount Royal Plum



Pyrus communis 'Beurre Bosc' Pear Beurre Bosc

UNDERSTOREY PLANTING

Climbers



Clematis aristata



Crowea exalata Crowea



Doodia aspera Prickly Rasp Fern



Dichondra argentea 'Silver Falls' Silver Pony-foot



Hardenbergia violacea Purple Coral-pea



Choisya ternata Mock Orange



Hosta



Grevillea juniperina Prostrate forms



Pandorea pandorana Wonga Vine



Indigofera australis Austral Indigo



Viola hederacea Ivy-leaf Violet



ATTACHMENT 2 - LEGISLATIVE REQUIREMENTS

5.1 PLANNING AND ENVIRONMENT ACT 1987 (THE ACT)

The *Planning and Environment Act 1987* is the relevant legislation governing planning in Victoria. The Act identifies subordinate legislation in the form of Planning Schemes to guide future land use and development.

Section 60 of The *Planning and Environment Act*, requires the Responsible Authority to consider the following before deciding on an application:

- The relevant planning scheme;
- The objectives of planning in Victoria;
- All objections and other submissions which it has received and which have not been withdrawn;
- Any decision and comments of a referral authority which it has received;
- Any significant effects which the responsible authority considers the use or development may have on the environment or which the responsible authority considers the environment may have on the use or development; and
- Any significant social effects and economic effects which the responsible authority considers the use or development may have.

Section 61(4) of the Act makes specific reference to covenants. Under Section 61(4) of the *Planning & Environment Act 1987* the Responsible Authority must not issue a planning permit that would result in a breach of a registered restrictive covenant.

5.2 MANNINGHAM PLANNING SCHEME

Clauses of the Manningham Planning Scheme the Responsible Authority must consider:

- State Planning Policy Framework
- Local Planning Policy Framework
- Clause 34.01 Commercial 1 Zone (C1Z)
- Clause 52.06 Car Parking
- Clause 52.29 (Land Adjacent to a Road Zone Category 1 or a Public Acquisition Overlay for a Category 1 Road)
- Clause 52.34 Bicycle Facilities
- Clause 65 Decision Guidelines

Zone

Clause 34.01 Commercial 1 Zone

The purpose of the Zone is:

- To implement the State Planning Policy Framework and the Local Planning Policy Framework, including the Municipal Strategic Statement and local planning policies.
- To create vibrant mixed use commercial centres for retail, office, business, entertainment and community uses.
- To provide for residential uses at densities complementary to the role and scale of the commercial centre.

A Planning Permit is required to construct a building or construct or carry out works, and for the use of the land for "accommodation".

State Planning Policy Framework

The relevant sections of the state planning policy framework are as follows:

Clause 11 – Settlement

Planning is to anticipate and respond to the needs of existing and future communities through provision of zoned and serviced land for housing, employment, recreation and open space, commercial and community facilities and infrastructure.

State Planning Policy Framework

The relevant sections of the state planning policy framework are as follows:

Clause 11.01-1 (Activity Centres) includes the objective to build up activity centres as a focus for high-quality development, activity and living for the whole community by developing a network of activity centres.

Clause 11.01-2 (Activity Centre Planning) includes the objective to encourage the concentration of major retail, residential, commercial, administrative, entertainment and cultural developments into activity centres which provide a variety of land uses and are highly accessible to the community.

Clause 15.01-1 (Urban Design) seeks to create urban environments that are safe, functional and provide good quality environments with a sense of place and cultural identity. Strategies towards achieving this are identified as follows:

- Promote good urban design to make the environment more liveable and attractive.
- Ensure new development or redevelopment contributes to community and cultural life by improving safety, diversity and choice, the quality of living and working environments, accessibility and inclusiveness and environmental sustainability.
- Require development to respond to its context in terms of urban character, cultural heritage, natural features, surrounding landscape and climate.
- Ensure transport corridors integrate land use planning, urban design and transport planning and are developed and managed with particular attention to urban design aspects.
- Encourage retention of existing vegetation or revegetation as part of subdivision and development proposals.

Clause 15.01-2 (Urban Design Principle) policy objective is:

 To achieve architectural and urban design outcomes that contribute positively to local urban character and enhance the public realm while minimising detrimental impact on neighbouring properties.

The strategy to achieve this is to apply the listed strategies to development proposals for non-residential development or residential development not covered by Clause 54, Clause 55 or Clause 56.

Responsible Authorities are also required to have regard to the State's *Design Guidelines for Higher Density Housing*, which is referenced at Clause 15.01 of the Scheme.

The strategies include the application of design principles to the proposed development relating to context, public realm, safety, pedestrian spaces, energy and resource efficiency, architectural quality and landscape quality.

Clause 15.01-4 (Design for Safety) policy objective is:

• To improve community safety and encourage neighbourhood design that makes people feel safe.

The policy seeks to improve community safety and encourage neighbourhood design that makes people feel safe. The strategy identified to achieve this objective is to ensure the design of buildings, public spaces and the mix of activities contribute to safety and perceptions of safety.

Clause 15.01-5 (Cultural Identity and Neighbourhood Character) policy objective is:

• To recognise and protect cultural identity, neighbourhood character and sense of place.

The clause includes several strategies to achieve this objective, including to:

- Ensure development responds and contributes to existing sense of place and cultural identity.
- Ensure development recognises distinctive urban forms and layout and their relationship to landscape and vegetation.
- Ensure development responds to its context and reinforces special characteristics of local environment and place by emphasising:
- The underlying natural landscape character.
- The heritage values and built form that reflect community identity.
- The values, needs and aspirations of the community.

Clause 15.02-1 Sustainable development: Energy and resource efficiency The policy objective is:

• To encourage land use and development that is consistent with the efficient use of energy and the minimisation of greenhouse gas emissions.

The clause has the following strategies:

- Ensure that buildings and subdivision design improves efficiency in energy use.
- Promote consolidation of urban development and integration of land use and transport.
- Improve efficiency in energy use through greater use of renewable energy.
- Support low energy forms of transport such as walking and cycling.

Clause 16.01-1 Residential development: Integrated housing The policy objective is:

To promote a housing market that meets community needs.

The clause has the following strategies:

- Increase the supply of housing in existing urban areas by facilitating increased housing yield in appropriate locations, including under-utilised urban land.
- Ensure that the planning system supports the appropriate quantity, quality and type of housing, including the provision of aged care facilities.
- Ensure housing developments are integrated with infrastructure and services, whether they are located in existing suburbs, growth areas or regional towns.
- Encourage housing that is both water efficient and energy efficient.

Clause 16.01-2 Residential development: Location of residential development The policy objective is:

• To locate new housing in or close to activity centres and employment corridors and at other strategic redevelopment sites that offer good access to services and transport.

The clause includes several strategies to achieve this objective, they include:

• Increase the proportion of housing in Metropolitan Melbourne to be developed within the established urban area, particularly at activity centres, employment corridors and at

- other strategic sites, and reduce the share of new dwellings in greenfield and dispersed development areas.
- Encourage higher density housing development on sites that are well located in relation to activity centres, employment corridors and public transport.
- Ensure an adequate supply of redevelopment opportunities within the established urban area to reduce the pressure for fringe development.
- Facilitate residential development that is cost-effective in infrastructure provision and use, energy efficient, incorporates water efficient design principles and encourages public transport use.
- Identify opportunities for increased residential densities to help consolidate urban areas.

Clause 16.01-3 Strategic redevelopment sites

The policy objective is:

• To identify strategic redevelopment sites for large residential development in Metropolitan Melbourne.

Specific reference is made at clause 16.01-3 to "strategic redevelopment sites" which are described as:

- in and around Central Activity Centres;
- in or within easy walking distance of Principal or Major Activity Centres;
- in or beside Neighbourhood Activity Centres that are well served by public transport;
- on or abutting tram, train, light rail and bus routes that are part of the Principal Public Transport Network and close to employment corridors, Central Activities Districts, Principal or Major Activity Centres;
- in or near major modal public transport interchanges that are not in Principal or Major Activity Centres;
- able to provide ten or more dwellings, close to activity centres and well served by public transport.

Clause 16.01-4 Housing diversity

The policy objective is:

• To provide for a range of housing types to meet increasingly diverse needs.

Clause 18.01-1 integrated Transport: Land use and transport planning The policy objective is:

To create a safe and sustainable transport system by integrating land-use and transport.

Clause 18.02-1 Movement networks: Sustainable personal transport The policy objective is:

• To promote the use of sustainable personal transport.

Clause 18.02-2 Cycling

The policy objective is:

• To integrate planning for cycling with land use and development planning and encourage as alternative modes of travel.

The clause includes several strategies to achieve this objective including to:

Require the provision of adequate bicycle parking and related facilities to meet demand at education, recreation, shopping and community facilities and other major attractions when issuing planning approvals.

Clause 18.02-4 Management of the road system

The policy objective is:

 To manage the road system to achieve integration, choice and balance by developing and efficient and safe network and making the most of existing infrastructure.

Clause 18.02-5 Car parking

The policy objective is:

To ensure an adequate supply of car parking that is appropriately designed and located.

The policy is relevant to the proposal because the application seeks a reduction in the standard car parking requirement of the Scheme. The objective is to ensure an adequate supply of car parking that is appropriately designed and located. It is also required to allocate or require land to be set aside for car parking subject to the existing and potential modes of access including public transport, the demand for off-street car parking, road capacity and the potential for demand management of car parking. Proposals are also encouraged to facilitate the use of public transport.

Clause 18.01- Integrated Transport

The objective of this policy is:

 To create a safe and sustainable transport system by integrating land-use and transport

Local Planning Policy Framework (LPPF)

Clause 21.02 Municipal Profile

Municipal Strategic Statement

Clause 21.03 Key Influences

This clause identifies that future housing need and residential amenity are critical land-use issues that will challenge Manningham's future growth and sustainable development. The MSS acknowledges that there is a general trend towards smaller household size as a result of an aging population and smaller family structure which will lead to an imbalance between the housing needs of the population and the actual housing stock that is available.

This increasing pressure for re-development raises issues about how these changes affect the character and amenity of our local neighbourhoods. In meeting future housing needs, the challenge is to provide for residential re-development in appropriate locations, to reduce pressure for development in more sensitive areas, and in a manner that respects the residential character and amenity valued by existing residents.

Clause 21.05 Residential

This policy outlines the division of Manningham into four Residential Character Precincts. The precincts seek to channel increased housing densities around activity centres and main roads where facilities and services are available. In areas which are removed from these facilities a lower intensity of development is encouraged. A low residential density is also encouraged in areas that have identified environmental or landscape features.

The site is within "Precinct 2 –Residential Areas Surrounding Activity Centres and Along Main Roads".

A substantial level of change is anticipated in Precinct 2 with these areas being a focus for higher density developments.

The Clause recognises the role of the Pines Activity Centre as a key Activity Centre within the municipality and provides a range of retail, commercial, community facilities and residential development opportunities.

Whilst not specifically relevant to the site , the residential area around The Pines Activity Centre (shown on Manningham Planning Scheme maps as DDO9) is an area where

development ranging in height from 11 metres to 16 metres is encouraged in designated areas, as identified in The Pines Activity Centre Structure Plan (2011).

Clause 21.05-2 Housing

The relevant objectives of this policy are:

- To accommodate Manningham's projected population growth through urban consolidation, in infill developments and Key Redevelopment Sites.
- To ensure that housing choice, quality and diversity will be increased to better meet the needs of the local community and reflect demographic changes.
- To ensure that higher density housing is located close to activity centres and along main roads in accordance with relevant strategies.
- To promote affordable and accessible housing to enable residents with changing needs to stay within their local neighbourhood or the municipality.
- To encourage development of key Redevelopment Sites to support a diverse residential community that offers a range of dwelling densities and lifestyle opportunities.
- To encourage high quality and integrated environmentally sustainable development.

The strategies to achieve these objectives include:

- Ensure that the provision of housing stock responds to the needs of the municipality's population.
- Promote the consolidation of lots to provide for a diversity of housing types and design options.
- Ensure higher density residential development occurs around the prescribed activity centres and along main roads identified as Precinct 2 on the Residential Framework Plan 1 and Map 1 to this clause.
- Encourage development to be designed to respond to the needs of people with limited mobility, which may for example, incorporate lifts into three storey developments.

Clause 21.09 Activity Centres and Commercial Areas

This section applies to all activity centres and commercial areas identified in Framework Plan 5.

The Clause acknowledges that the Pines, East Doncaster is the municipality's one and only Major Activity Centre.

The vision for the Pines Activity Centre will continue to be a focus for the community and to provide for their retail, community, recreational and entertainment needs as well as providing for a diversity of residential options within its context of being on the fringe of the metropolitan area of Melbourne and its proximity to the Green Wedge.

Key Strategic Objectives are:

- Support the development of The Pines Activity Centre which meets the social, recreational and retail needs of the population at the sub-regional level.
- Ensure that any future development in The Pines Activity Centre is in keeping with its location on the fringe of the urban area and its proximity to the Green Wedge.
- Encourage apartment style development within The Pines Activity Centre to maximise the use of the commercial and social facilities provided within and to provide alternative housing options for the locality.
- Encourage greater use of public transport to and from The Pines Activity Centre and advocate for more services and for these services to be provided more frequently.

- Enhance the public realm within The Pines Activity Centre by ensuring that the public spaces meet a range of community needs, are well linked together, are easily accessible, safe and visually pleasing.
- Maximise use of the area's natural strengths such as views to surrounding rural and bushland areas in keeping with the community interest.
- Support housing choices to meet changing demographic trends, especially an ageing population.
- Support a range of health, family and professional services relevant to the role of The Pines Activity Centre.
- Support a range of education and learning activities to meet the needs and aspirations of the local community.
- Provide for well defined vehicular, bicycle and pedestrian access both with and external to all precincts, with strong pedestrian crossing points to be established on main roads.

Clause 21.10 Environmentally Sustainable Development

Council's Environmentally Sustainable Development Policy seeks to achieve best practice design, construction and operation for new development.

A number of considerations are to be made under the headings: key issues, objectives, and strategies.

Local Planning Policy

Clause 22.08 Safety through urban design

This policy applies to all land in Manningham. It endeavours to provide and maintain a safer physical environment for those who live in, work in or visit the City of Manningham. The policy seeks attractive, vibrant and walkable public spaces where crime, graffiti and vandalism in minimised.

Clause 22.09 Access for disabled people

This policy also applies to all land in Manningham. It seeks to ensure that people with a disability have the same level of access to buildings, services and facilities as any other person. The policy requires the needs of people with a disability to be taken into account in the design of all proposed developments.

Clause 22.12 Environmentally Sustainable Development

This policy applies throughout the City of Manningham to residential and non-residential development that requires a planning permit in accordance with the thresholds in Table 1 of this Policy (except for land affected by the Activity Centre Zone (Schedule 1) that applies to Doncaster Hill). The policy contains an overarching objective that development should achieve best practice in environmentally sustainable development from the design stage through to construction and operation.

Particular Provisions

Clause 52.06 Car Parking

Pursuant to Clause 52.06-5, car parking is required to be provided at the following rate:

- 1 space for 1 and 2 bedroom dwellings
- 2 spaces for 3 or more bedroom dwellings
- 1 visitor space to every 5 dwellings for developments of 5 or more dwellings

Clause 52.06-8 outlines various design standards for parking areas that should be achieved.

<u>Clause 52.29 Land Adjacent to a Road Zone Category 1 (RDZ1) or a Public Acquisition</u> <u>Overlay for a Category 1 Road</u>

The purpose of this provision is:

- To ensure appropriate access to identified roads
- To ensure appropriate subdivision of land adjacent to identified roads.

A permit is required to create or alter access to a road in a Road Zone, Category 1.

Clause 52.34 Bicycle Facilities

Pursuant to Clause 52.34-3, the following number of bicycle spaces are required in development of four or more storeys:

- 1 space for every 5 dwellings for residents.
- 1 space for every 10 dwellings for visitors.
- 1 to each 8 practitioners for medical centre employees
- 1 to each 4 practitioners for visitors
- 1 to each 300sqm of retail floor area for employees
- 1 to each 500sqm of retail floor area for visitors

General Provisions

Clause 65 Decision Guidelines

This clause outlines that before deciding on an application, the responsible authority must consider, as appropriate:

- The State Planning Policy Framework and the Local Planning Policy Framework, including the Municipal Strategic Statement and local planning policies.
- The purpose of the zone, overlay or other provision.
- The orderly planning of the area.
- The effect on the amenity of the area.

The Pines Activity Centre Structure Plan (2011) Summary

1.1. The Pines Structure Plan

The Pines Structure Plan 2011 provides a framework to guide future development and land use over a 20 year period for the area identified as The Pines Activity Centre. The 2011 Structure Plan provides the vision and objectives for The Pines Activity Centre and establishes strategic directions for the precincts within.

The Structure Plan has been prepared from a review of the 1992 Pines Activity Centre Structure Plan and an assessment of current issues and projected needs for the future including feedback from residents and major stakeholders. The State Government, through their strategy, *Melbourne 2030*, has classified The Pines Activity Centre as a Major Activity Centre. Councils are required to prepare and keep up to date structure plans for Major Activity Centres. Major Activity Centres are required to provide for a range of commercial and community services and facilities that are grouped in one area and are easily accessible. *Melbourne 2030* encourages more efficient use of residential land by supporting higher density development, such as apartments and town houses to be provided within Major Activity Centres.

The Pines Activity Centre Structure Plan is supported by the former Structure Plan, The Pines Activity Centre Structure Plan 1992; the Retail and Commercial Assessment of the Pines Major Activity Centre, Tim Nott, December 2008; and The Pines Structure Plan, Issues Paper, September 2009.

The draft *Pines Activity Centre Structure Plan* was adopted by Council on 27 April 2010 for public exhibition and consultation. The draft *Pines Activity Centre Structure Plan, May 2010* was made available for public comment for six weeks. At the 31 August 2010 Meeting, Council considered the draft Structure Plan and the 30 submissions received in response. At the meeting, Council approved the draft Structure Plan, with changes, to form the basis for the future planning of the Pines Activity Centre.

1.2. The Purpose of The Pines Structure Plan

The purpose of The Pines Structure Plan is:

- To provide certainty to the local community and investors about the future form and use of the Pines Activity Centre;
- To manage change to ensure that The Pines Activity Centre remains vibrant and an attractive place to visit and or live;
- To guide decision-makers and other relevant key stakeholders at State and local level regarding works and initiatives;
- To guide future use and development in a manner that is consistent with state and local planning policy;
- To direct Council resources to best serve the regional and local community.

2. Vision and Objectives

2.1. Vision for The Pines Activity Centre

The Pines Activity Centre Structure Plan 1992 provided the following vision "the opportunity exists to create a major community focus at The Pines Activity Centre. The Activity Centre will provide for retail, community, recreational, entertainment and residential land uses clustered and integrated to serve the needs of residents in the surrounding area."

Building upon the former statement, the following vision for The Pines Activity Centre Structure Plan is:

"The Pines Activity Centre will continue to be a focus for the community and to provide for their retail, community, recreational and entertainment needs as well as providing for a diversity of residential options within its context of being on the fringe of the metropolitan area of Melbourne and its proximity to the green wedge".

2.2. General Strategic Objectives


The strategic objectives for The Pines Structure Plan have been developed from a review of the goals and strategies of the previous Structure Plan and from an assessment of current issues and broad aims for land use and development in the future. The broad strategic objectives for the overall Activity Centre follow:


- 2.2.1. Support the development of the Pines Activity Centre which meets the social, recreational and retail needs of the population at the sub-regional level.
- 2.2.2. Ensure that any future development in The Pines Activity Centre is in keeping with its location on the fringe of the urban area and its proximity to the green wedge.
- 2.2.3. Encourage apartment style development within The Pines Activity Centre to maximise the use of the commercial and social facilities provided within and to provide alternative housing options for the locality.
- 2.2.4. Encourage greater use of public transport to and from The Pines Activity Centre and advocate for more services and for these services to be provided more frequently.
- 2.2.5. Enhance the public realm within the Pines Activity Centre by ensuring that the public spaces meet a range of community needs, are well linked together, are safe and are visually pleasing.
- 2.2.6. Maximise use of the area's natural strengths such as views to surrounding rural and bushland areas in keeping with the community interest.
- Support housing choices to meet changing demographic trends, especially an ageing population.
- 2.2.8. Support a range of health, family and professional services relevant to the role of The Pines Activity Centre.
- Support a range of education and learning activities to meet the needs and aspirations of the local community.
- Create a consistent landscaped theme, sense of place and branding that easily distinguishes The Pines Activity Centre from other centres.
- 2.2.11. Provide for well defined vehicular, bicycle and pedestrian access both within and external to all precincts, with strong pedestrian crossing points to be established on main roads.

2.3. Commercial Development Strategic Objectives

Providing for an expansion in commercial uses and development to meet increased local needs, such as additional retail, office and entertainment activities and supporting local employment.

- Provide for an increase in retail and office floor space to meet the future needs of the sub regional population.
- 2.3.2. Ensure that any new development gives highest priority to pedestrian circulation.
- 2.3.3. Encourage outwardly focussed retail facilities with provisions for goods display areas which address streetscape and which are visible from the building's exterior. Encourage the building façade at street level to be inviting and interesting to pedestrians.
- 2.3.4. Ensure that any new commercial development is integrated with the existing shopping centre and that such development retains a family friendly and local community environment.
- Ensure that any new commercial development does not detract from the viability and vitality
 of surrounding neighbourhood centres.
- Support the establishment of land uses which have minimal impacts on residential amenity.
- 2.3.7. Encourage the development of restaurants or public spaces on the top level of the shopping centre to allow the community to enjoy the surrounding views of the Kinglake mountains and Dandenong Ranges.

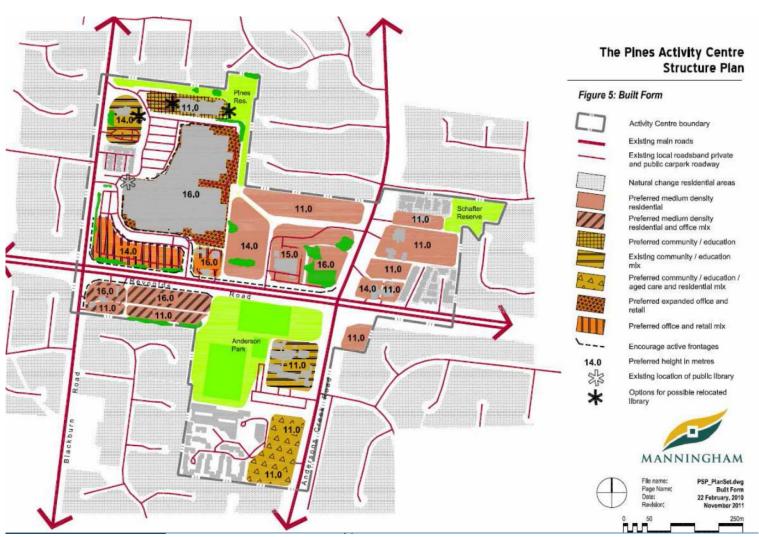

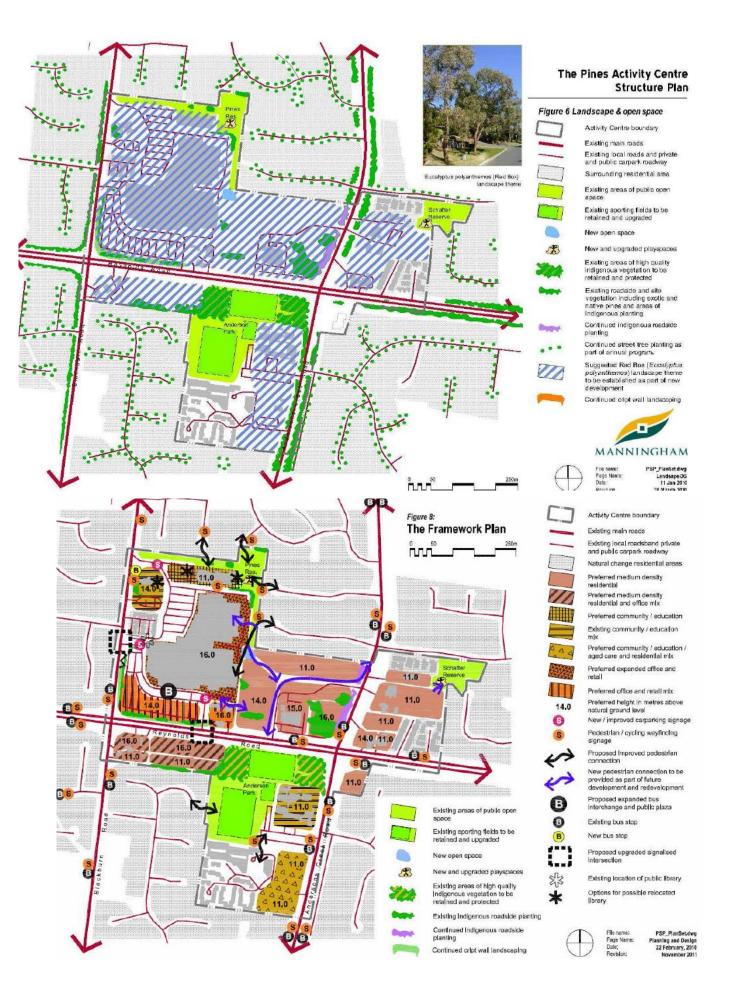

5. Precinct Actions

The Pines Activity Centre contains six precincts as shown in the following Development Framework Plan. The following section provides specific objectives and actions relating to each precinct. It should be noted that in terms of timing, Short term (S) is within the first 5 years, Medium term (M) within 5-10 years and Long term (L) within 10 to 20 years.

Precinct 1 – Retail and Commercial Core

The retail core currently comprises The Pines Shopping Centre and surrounding carpark. The centre has been expanded and refurbished in 2005 and now contains 19,120 sq m of retail floor space and 1,880 sq m of other commercial space. Precinct 1 also includes the petrol filling service station and a block of apartments.



Key	Action	Stakeholders	Timing
1.1	Promote retail and commercial development within the existing surface carpark to give a visual presence to Reynolds Road. Provide for an additional expansion of between 4,000 and 10,000 sq. m of retail and 2,000 sq m of office floorspace on the existing site and sufficient car spaces to meet these needs.	Stocklands/MCC	L
1.2	Advocate for an appropriate design and expansion of the bus interchange to provide for additional bus services by doubling the bus spaces. Improve pedestrian and cycle access and amenities (e.g. provide for all weather protection, bike storage).	DOT/Stocklands/ MCC	s
1.3	Encourage the creation of high quality urban plazas.	Stocklands/MCC	L
1.4	Investigate opportunities to improve pedestrian amenity with introduction of yellow orbital bus service	DOT/Stocklands/ MCC	L
1.5	Review the disability access to The Pines	Stocklands	S
1.6	To undertake a detailed feasibility study including potential funding sources and advocacy for the relocation of The Pines	Stocklands/users of the library	s

	Library and the future of the Warrandyte Library.		
1.7	Review access points into the shopping centre, in particular, review the pedestrian and vehicular entry from Blackburn Road.	DOT/Stocklands/ MCC	s
Key	Action	Stakeholders	Timing

Precinct 1 - Retail and Commercial Core


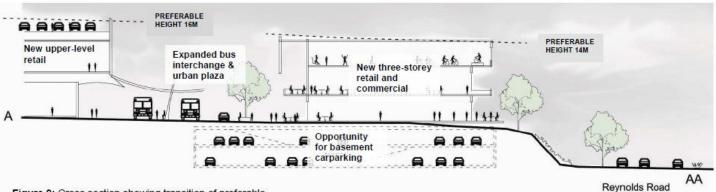


Figure 9: Cross section showing transition of preferable heights, the opportunity for the expansion of the existing bus interchange, the creation of an urban plaza, and new basement and rooftop parking.

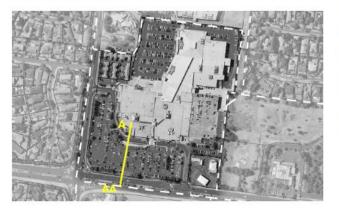

Height

The cross section above provides an indication of the scale of the preferable development in Precinct 1. The cross section shows a second level of retail and a possible upper-level parking deck within the existing Pines Shopping Centre footprint and a new three storey retail and commercial building in place of what is now a surface carpark to the south.

Landscape character

The landscape vision for the precinct is for an improved presentation to Blackburn and Reynolds Roads, with feature weeping planting / other obscuring the existing crypt wall and ornamental shade trees within newly created urban spaces.

Built form

The vision for this precinct is for continued high-quality retail and commercial development that has an address to Reynolds and Blackburn Roads. Provision of replacement underground and additional rooftop carparking will provide opportunity for the expansion of the existing bus interchange and the creation of an urban plaza. Ground-level retail space surrounding the newly expanded plaza and bus interchange should incorporate uses that will assist in activating this space. Upper-level retail and commercial spaces should maximise access to panoramic views.

ATTACHMENT 3: Map of objector properties WINIFRED CT HERMANN CT PORTER ST PORTERST HAKEA ST VERBENA 65 HOVEA 6 181 Reynolds Road ALDERT ST ROBMLE RS MORELLO DIR GARDENVIEW CT KOLOR WAY THE PLANS CRICKLEWOOD DR WOODLEA 87 SERPELLS TOE BOTANIC DR ROSELAND GV LESLEST STANDRING CL ARELIA ST CORREACT JOCELYN CELESTE ST DONCASTER RD AMTREE AV RODERICK ST BEVERLEY ST REVERLEY ST BARD ST SOUTH ELEANOR CT TRISTANIA ST